

Scale: NTS



Planting Legend



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Proposed street trees - refer detail public domain plans



Bio-retention groundcover Mix to WSUD planting area - refer detail public domain plans and Matrix detail

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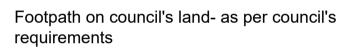
Planting Mix 1 - refer detail public domain plans and Matrix detail

Planting Mix 2 - refer detail public domain plans and Matrix detail

Other Landscape Items



Proposed grass verge - as per council's requirements Retaining wall proposed by Civil engineer - refer to Civil eng's details



Street tree planting refer to Liverpool Council's Growth Centre Precincts Development Control Plan Table 3-5 Street tree requirements/ Tree guard detail refer to Typical detail



Casual sandstone seats - refer detail



Pit- refer to Civil eng's detail




Existing Transmission Easement



Bin collection area

DRAWING	SCHEDULE	
SHEET #	DRAWING TITLE	REV.
/1	SITE PLAN	С
/2	PUBLIC DOMAIN 1	С
/3	PUBLIC DOMAIN 2	С
/4	PUBLIC DOMAIN 3	С
/5	TYPICAL ROAD SECTIONS	С
/6	SPECIFICATION+DETAILS	С

	TITLE:		STATUS:		
	SITE PLAN/TITLE		DEVELOPMENT APPLICATION		
			SCALE:	DATE:	
			1:300 @ A1	OCT 2023	
	DWG.No:	PAGE NUMBER:	DRAWN:	CHECKED:	
	LPDA 23 - 198	1	C.D	R.F	

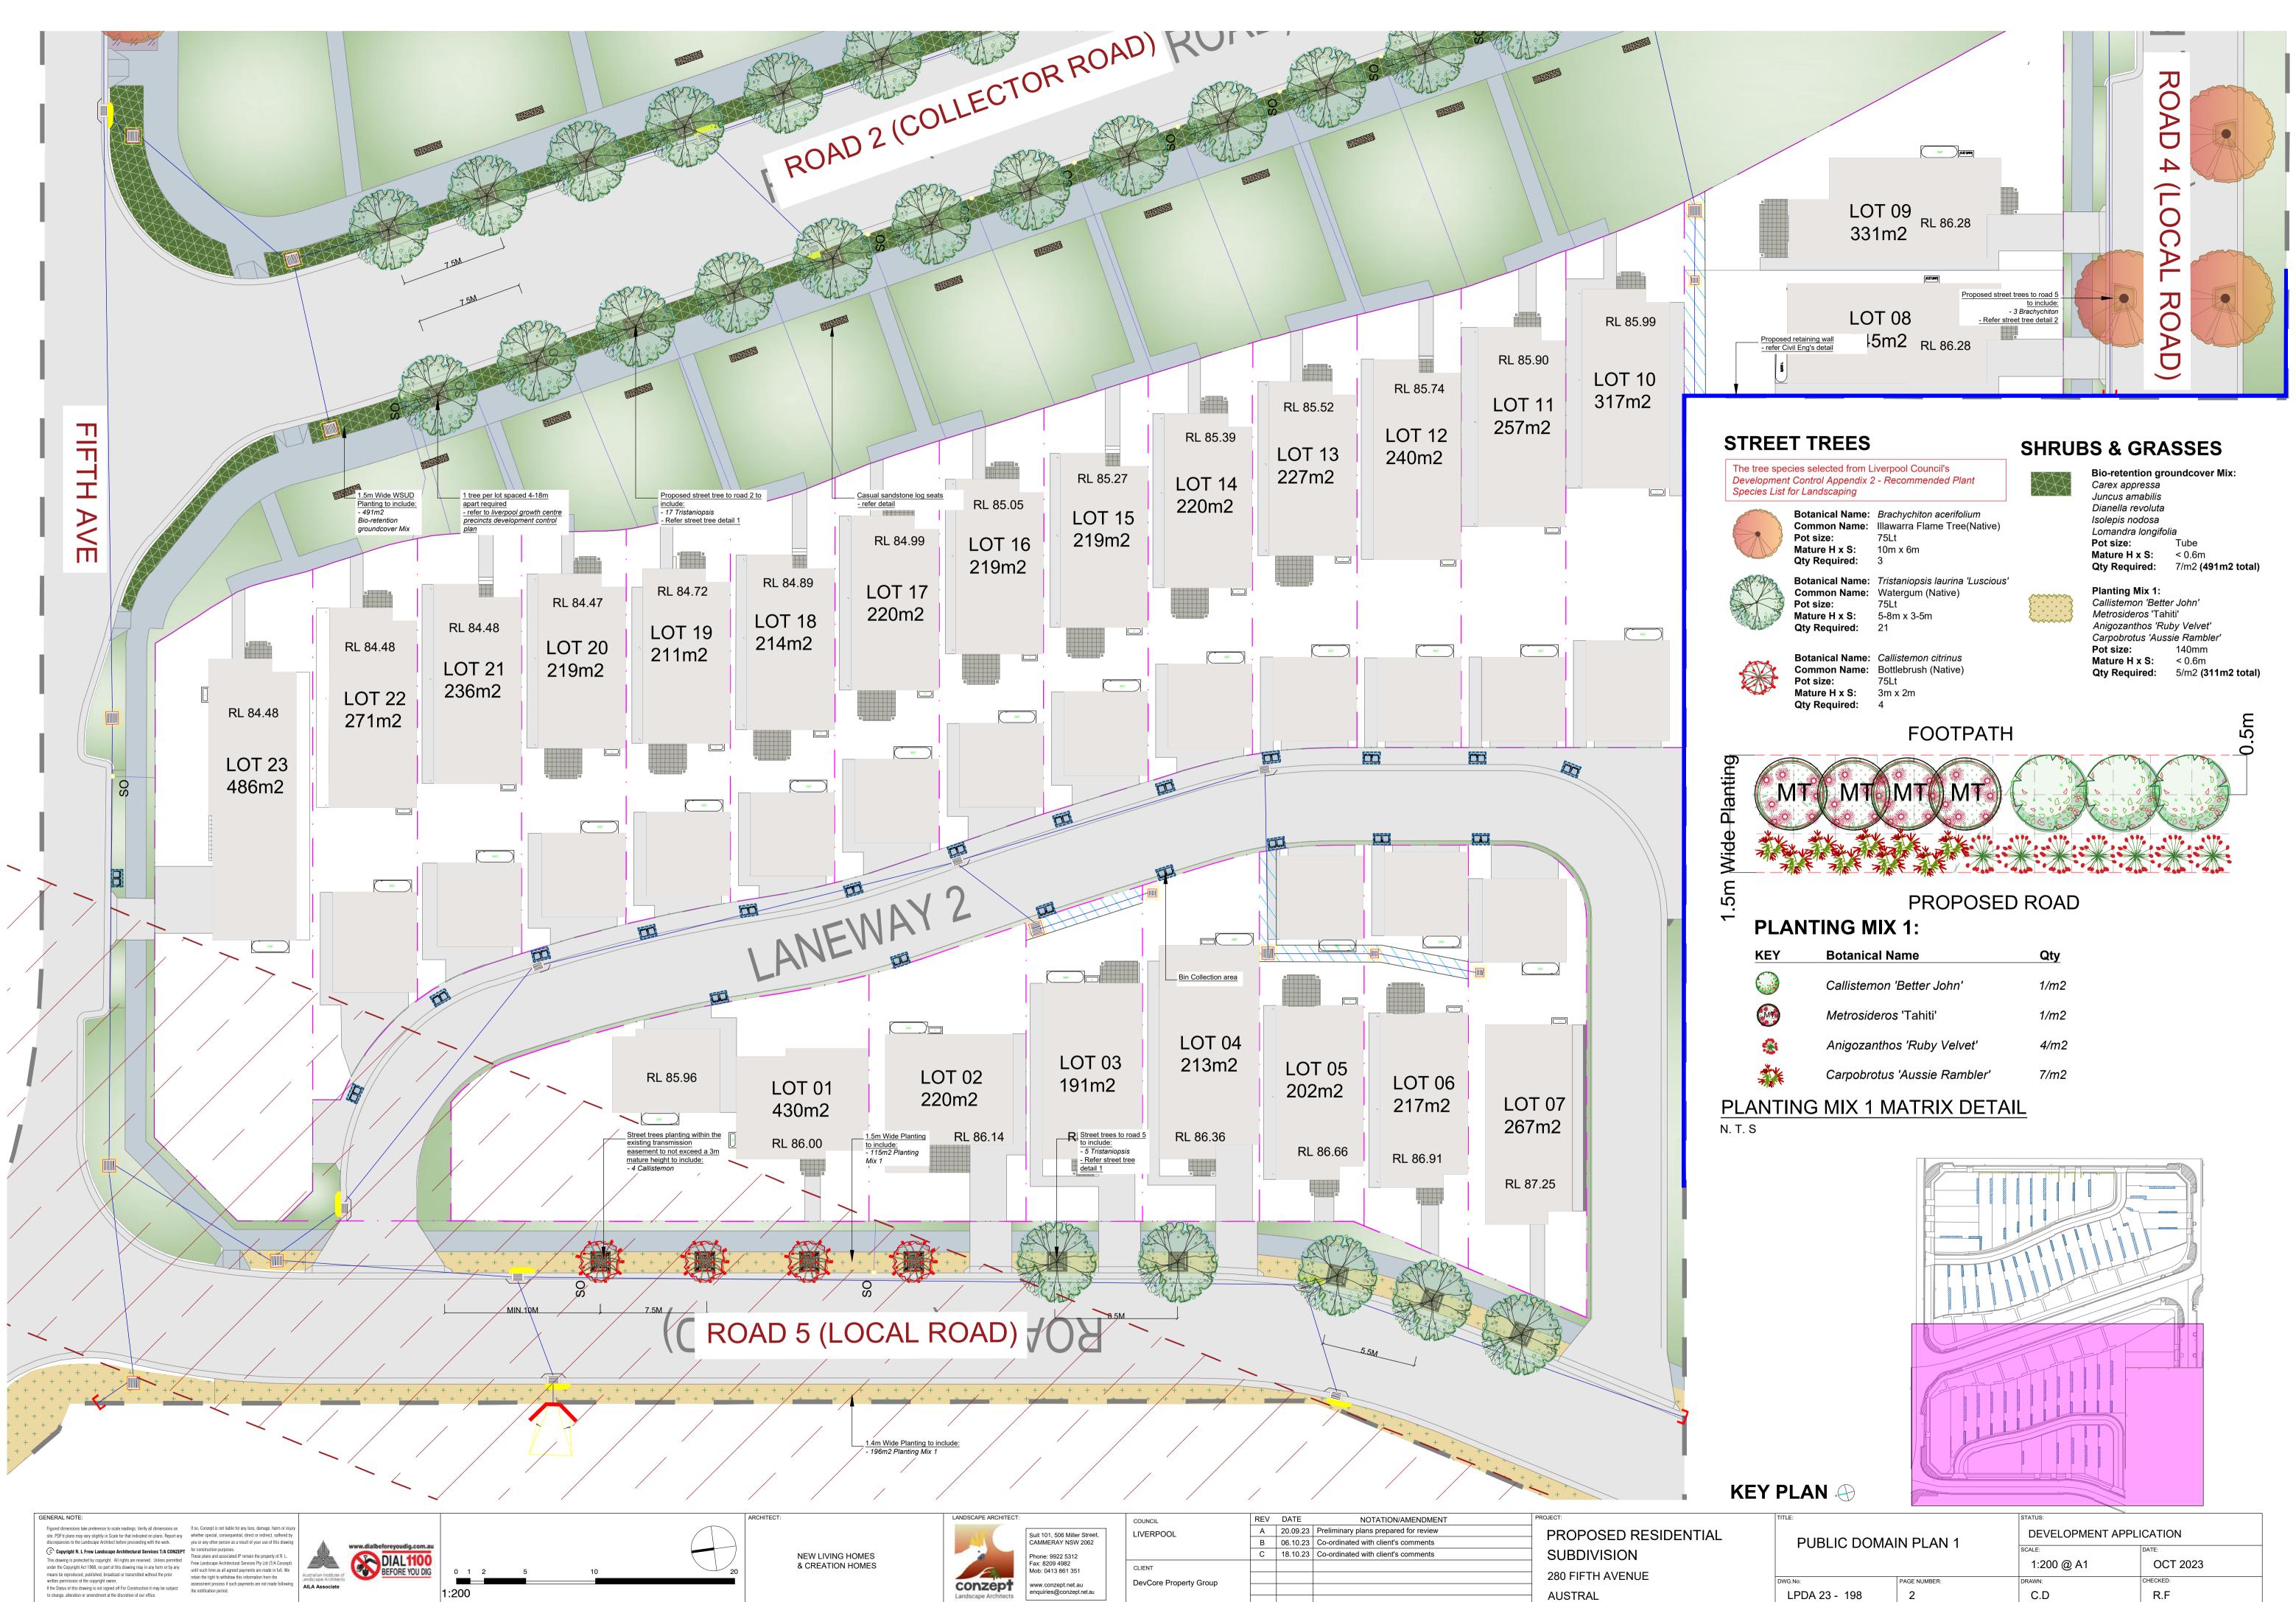

KEY	Botanical Name	Qty
	Callistemon 'Better John'	1/m2
	Metrosideros 'Tahiti'	1/m2
*	Anigozanthos 'Ruby Velvet'	4/m2
	Carpobrotus 'Aussie Rambler'	7/m2

	PUBLIC DOMAIN PLAN 1		STATUS: DEVELOPMENT APPLICATION	
			^{scale:} 1:200 @ A1	DATE: OCT 2023
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	LPDA 23 - 198	2	C.D	R.F

NOTES:

1. ALL FINAL PLANT QUANTITIES INDICATED ON PLANS SHALL BE CHECKED AND VERIFIED BY SUCCESSFUL LANDSCAPE CONTRACTOR.

2. ANY PLANT SUBSTITUTES REQUIRED DUE TO UNAVAILABILITY SHALL BE RECOMMENDED BY THE LANDSCAPE CONTRACTOR TO BEST MATCH SUBSTITUTED PLANTS AND APPROVED PRIOR TO PURCHASING BY THE LANDSCAPE ARCHITECT. 3. WORKS CERTIFIED FOR FINAL OCCUPANCY CERTIFICATE ARE TO MATCH APPROVED LANDSCAPE PLANS.

4. LANDSCAPE CONTRACTOR SHALL LOCATE AND AVOID SITE STORM WATER & DRAINAGE SERVICES. LOCATE TREES A MINIMUM 1.25M FROM PITS 5. ALL PLANTING AROUND EXISTING TREES SHALL BE ADJUSTED TO AVOID

DAMAGE AND CLASHING WITH SURFACE ROOTS 6. THE NATURE STRIP (STREET FRONTAGE) FOR THE SITE IS PUBLIC LAND, AND ONLY AUTHORIZED WORKS MAY OCCUR HERE. EXISTING CONDITIONS SUCH AS STREET TREES, COUNCIL PLANTING ETC SHALL BE RETAINED AND PROTECTED DURING CONSTRUCTION, UNLESS SPECIFIC APPROVAL HAS BEEN GRANTED FOR NEW WORK IN THIS AREA.

7. ALL TREES TO BE SOURCED IN ACCORDANCE WITH TESTS AND MEASUREMENTS CONTAINED WITHIN AS 2303-2015 - TREE STOCK FOR LANDSCAPE USE

STREET TREES

The tree species selected from Liverpool Council's
Development Control Appendix 2 - Recommended Plant
Species List for Landscaping




Botanical Name: Brachychiton acerifolium **Common Name:** Illawarra Flame Tree(Native) 75Lt Pot size: Mature H x S: 10m x 6m Qty Required: 8 Botanical Name: Tristaniopsis laurina 'Luscious'

Pot size: Qty Required:

Common Name: Watergum (Native) 75Lt Mature H x S: 5-8m x 3-5m

SHRUBS & GRASSES

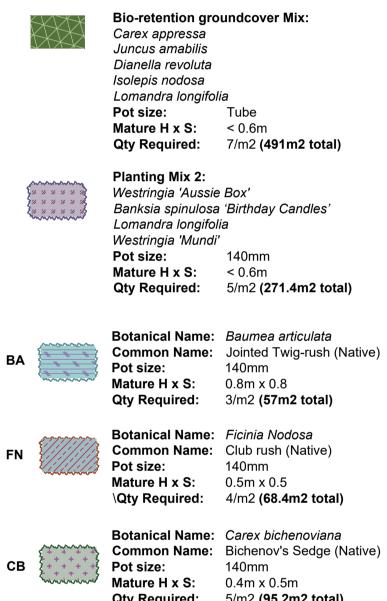

	2.0.000
Pot size:	140mm
Mature H x S:	0.4m x 0.5m
Qty Required:	5/m2 (95.2m2 total)
Botanical Name:	Juncus flavidus
Common Name:	Juncus (Native)
Pot size:	140mm
Mature H x S:	0.6m x 0.6 m
Qty Required:	5/m2 (54.6m2 total)


















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FOOTPATH

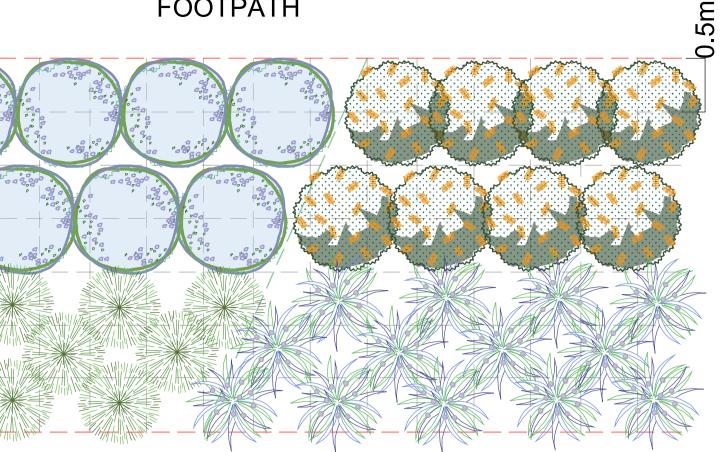


PROPOSED ROAD

PLANTING MIX 2:

KEY	Botanical Name	Qty
	Westringia 'Aussie Box'	1/m2
Ö	Banksia spinulosa 'Birthday Candles'	1/m2
	Lomandra longifolia	2/m2
***	Westringia 'Mundi	2/m2

PLANTING MIX 2 MATRIX DETAIL

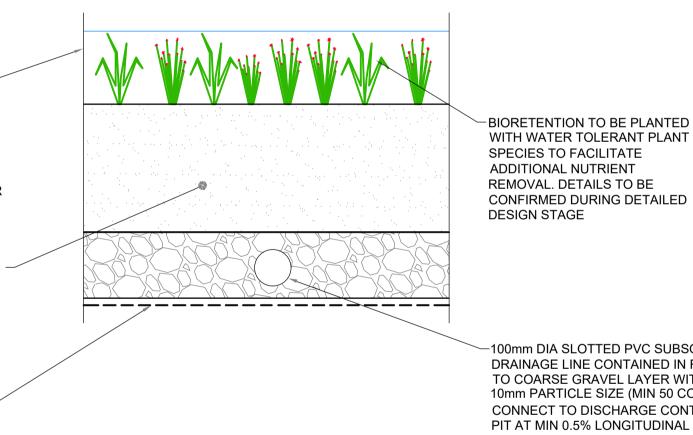

WITH WATER TOLERANT PLANT SPECIES TO FACILITATE ADDITIONAL NUTRIENT REMOVAL. DETAILS TO BE CONFIRMED DURING DETAILED

-100mm DIA SLOTTED PVC SUBSOIL DRAINAGE LINE CONTAINED IN FINE TO COARSE GRAVEL LAYER WITH NOM 10mm PARTICLE SIZE (MIN 50 COVER). CONNECT TO DISCHARGE CONTROL PIT AT MIN 0.5% LONGITUDINAL GRADE

BIORETENTION DETAIL (Refer Civil Eng's detail)

SAMPLE IMAGES Images are diagrammatic only, and final planting species may vary, as determined by Council Approval



Tristaniopsis laurina 'Luscious'



Brachychiton acerifolium

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NOTES:

1. ALL FINAL PLANT QUANTITIES INDICATED ON PLANS SHALL BE CHECKED AND VERIFIED BY SUCCESSFUL LANDSCAPE CONTRACTOR.

2. ANY PLANT SUBSTITUTES REQUIRED DUE TO UNAVAILABILITY SHALL BE

RECOMMENDED BY THE LANDSCAPE CONTRACTOR TO BEST MATCH SUBSTITUTED PLANTS AND APPROVED PRIOR TO PURCHASING BY THE LANDSCAPE ARCHITECT. 3. WORKS CERTIFIED FOR FINAL OCCUPANCY CERTIFICATE ARE TO MATCH

APPROVED LANDSCAPE PLANS.

4. LANDSCAPE CONTRACTOR SHALL LOCATE AND AVOID SITE STORM WATER & DRAINAGE SERVICES. LOCATE TREES A MINIMUM 1.25M FROM PITS 5. ALL PLANTING AROUND EXISTING TREES SHALL BE ADJUSTED TO AVOID DAMAGE AND CLASHING WITH SURFACE ROOTS

6. THE NATURE STRIP (STREET FRONTAGE) FOR THE SITE IS PUBLIC LAND, AND ONLY AUTHORIZED WORKS MAY OCCUR HERE. EXISTING CONDITIONS SUCH AS STREET TREES, COUNCIL PLANTING ETC SHALL BE RETAINED AND PROTECTED DURING CONSTRUCTION, UNLESS SPECIFIC APPROVAL HAS BEEN GRANTED FOR NEW WORK IN THIS AREA.

7. ALL TREES TO BE SOURCED IN ACCORDANCE WITH TESTS AND MEASUREMENTS CONTAINED WITHIN AS 2303-2015 - TREE STOCK FOR LANDSCAPE USE

STREET TREES

The tree species selected from Liverpool Council's Development Control Appendix 2 - Recommended Plant Species List for Landscaping




Botanical Name: Brachychiton acerifolium **Common Name:** Illawarra Flame Tree(Native) Pot size: 75Lt Mature H x S: 10m x 6m Qty Required: Botanical Name: Tristaniopsis laurina 'Luscious' **Common Name:** Watergum (Native)



75Lt Pot size: Mature H x S: 5-8m x 3-5m Qty Required: 21

SHRUBS & GRASSES

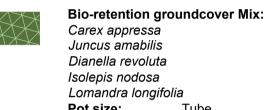

Carex appressa Juncus amabilis Dianella revoluta Isolepis nodosa Lomandra longifolia Tube Pot size: Mature H x S: < 0.6m Qty Required: 7/m2 (491m2 total)


Other Landscape Items



Proposed grass verge - as per council's requirements



Proposed retaining wall- refer to civil eng's detail Footpath on council's land- as per council's requirements

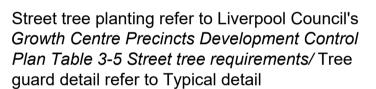

Casual sandstone seats - refer detail

Pit- refer to Civil eng's detail



Bin collection area





Proposed street tree to Livestock Road to include:


7 Tristaniopsis - Refer street tree detail 1

1 tree per lot spaced 4-18m

precincts development control

- refer to liverpool growth centre

apart required

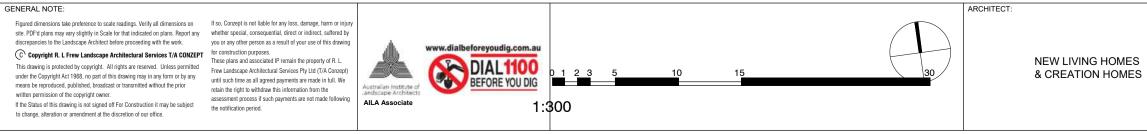


Phone: 9922 5312 Fax: 8209 4982 Mob: 0413 861 351 conzept www.conzept.net.au nquiries@conzept.net.au Landscape Architect

CLIENT

DevCore Property Group

SUBDIVISION C 18.10.23 Co-ordinated with client's comments 280 FIFTH AVENUE AUSTRAL

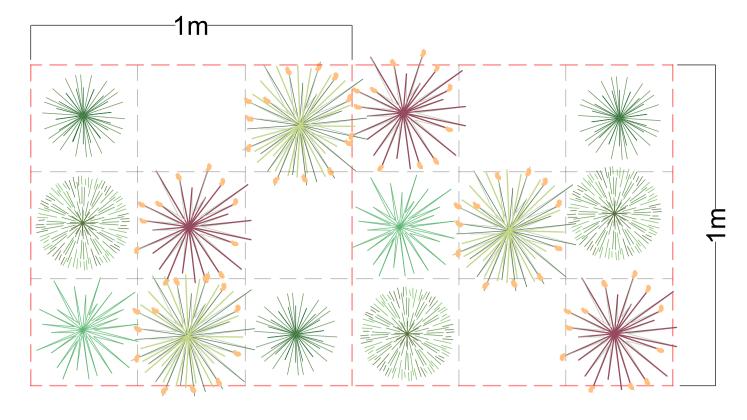

Groundcover Mix (Bio-retention) 7/m2 (20% each)

Botanical Name	
Carex appressa	
Juncus amabilis	
Dianella revoluta	
Isolepis nodosa	
Lomandra longifol	

Bio-retention groundcover Mix MATRIX DETAIL N. T. S

SAMPLE IMAGES

Images are diagrammatic only, and final planting species may vary, as determined by Council Approval





Westringia 'Aussie Box'



Anigozanthos 'Ruby Velvet'



Baumea articulata



Banksia spinulosa 'Birthday Candles'



Callistemon 'BetterJoh




Carpobrotus 'Aussie Rambl





Juncus flavidus

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	TYPICAL ROAD SECTIONS		STATUS: DEVELOPMENT APPLICATION	
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LANDSCAPE WORK SPECIFICATION

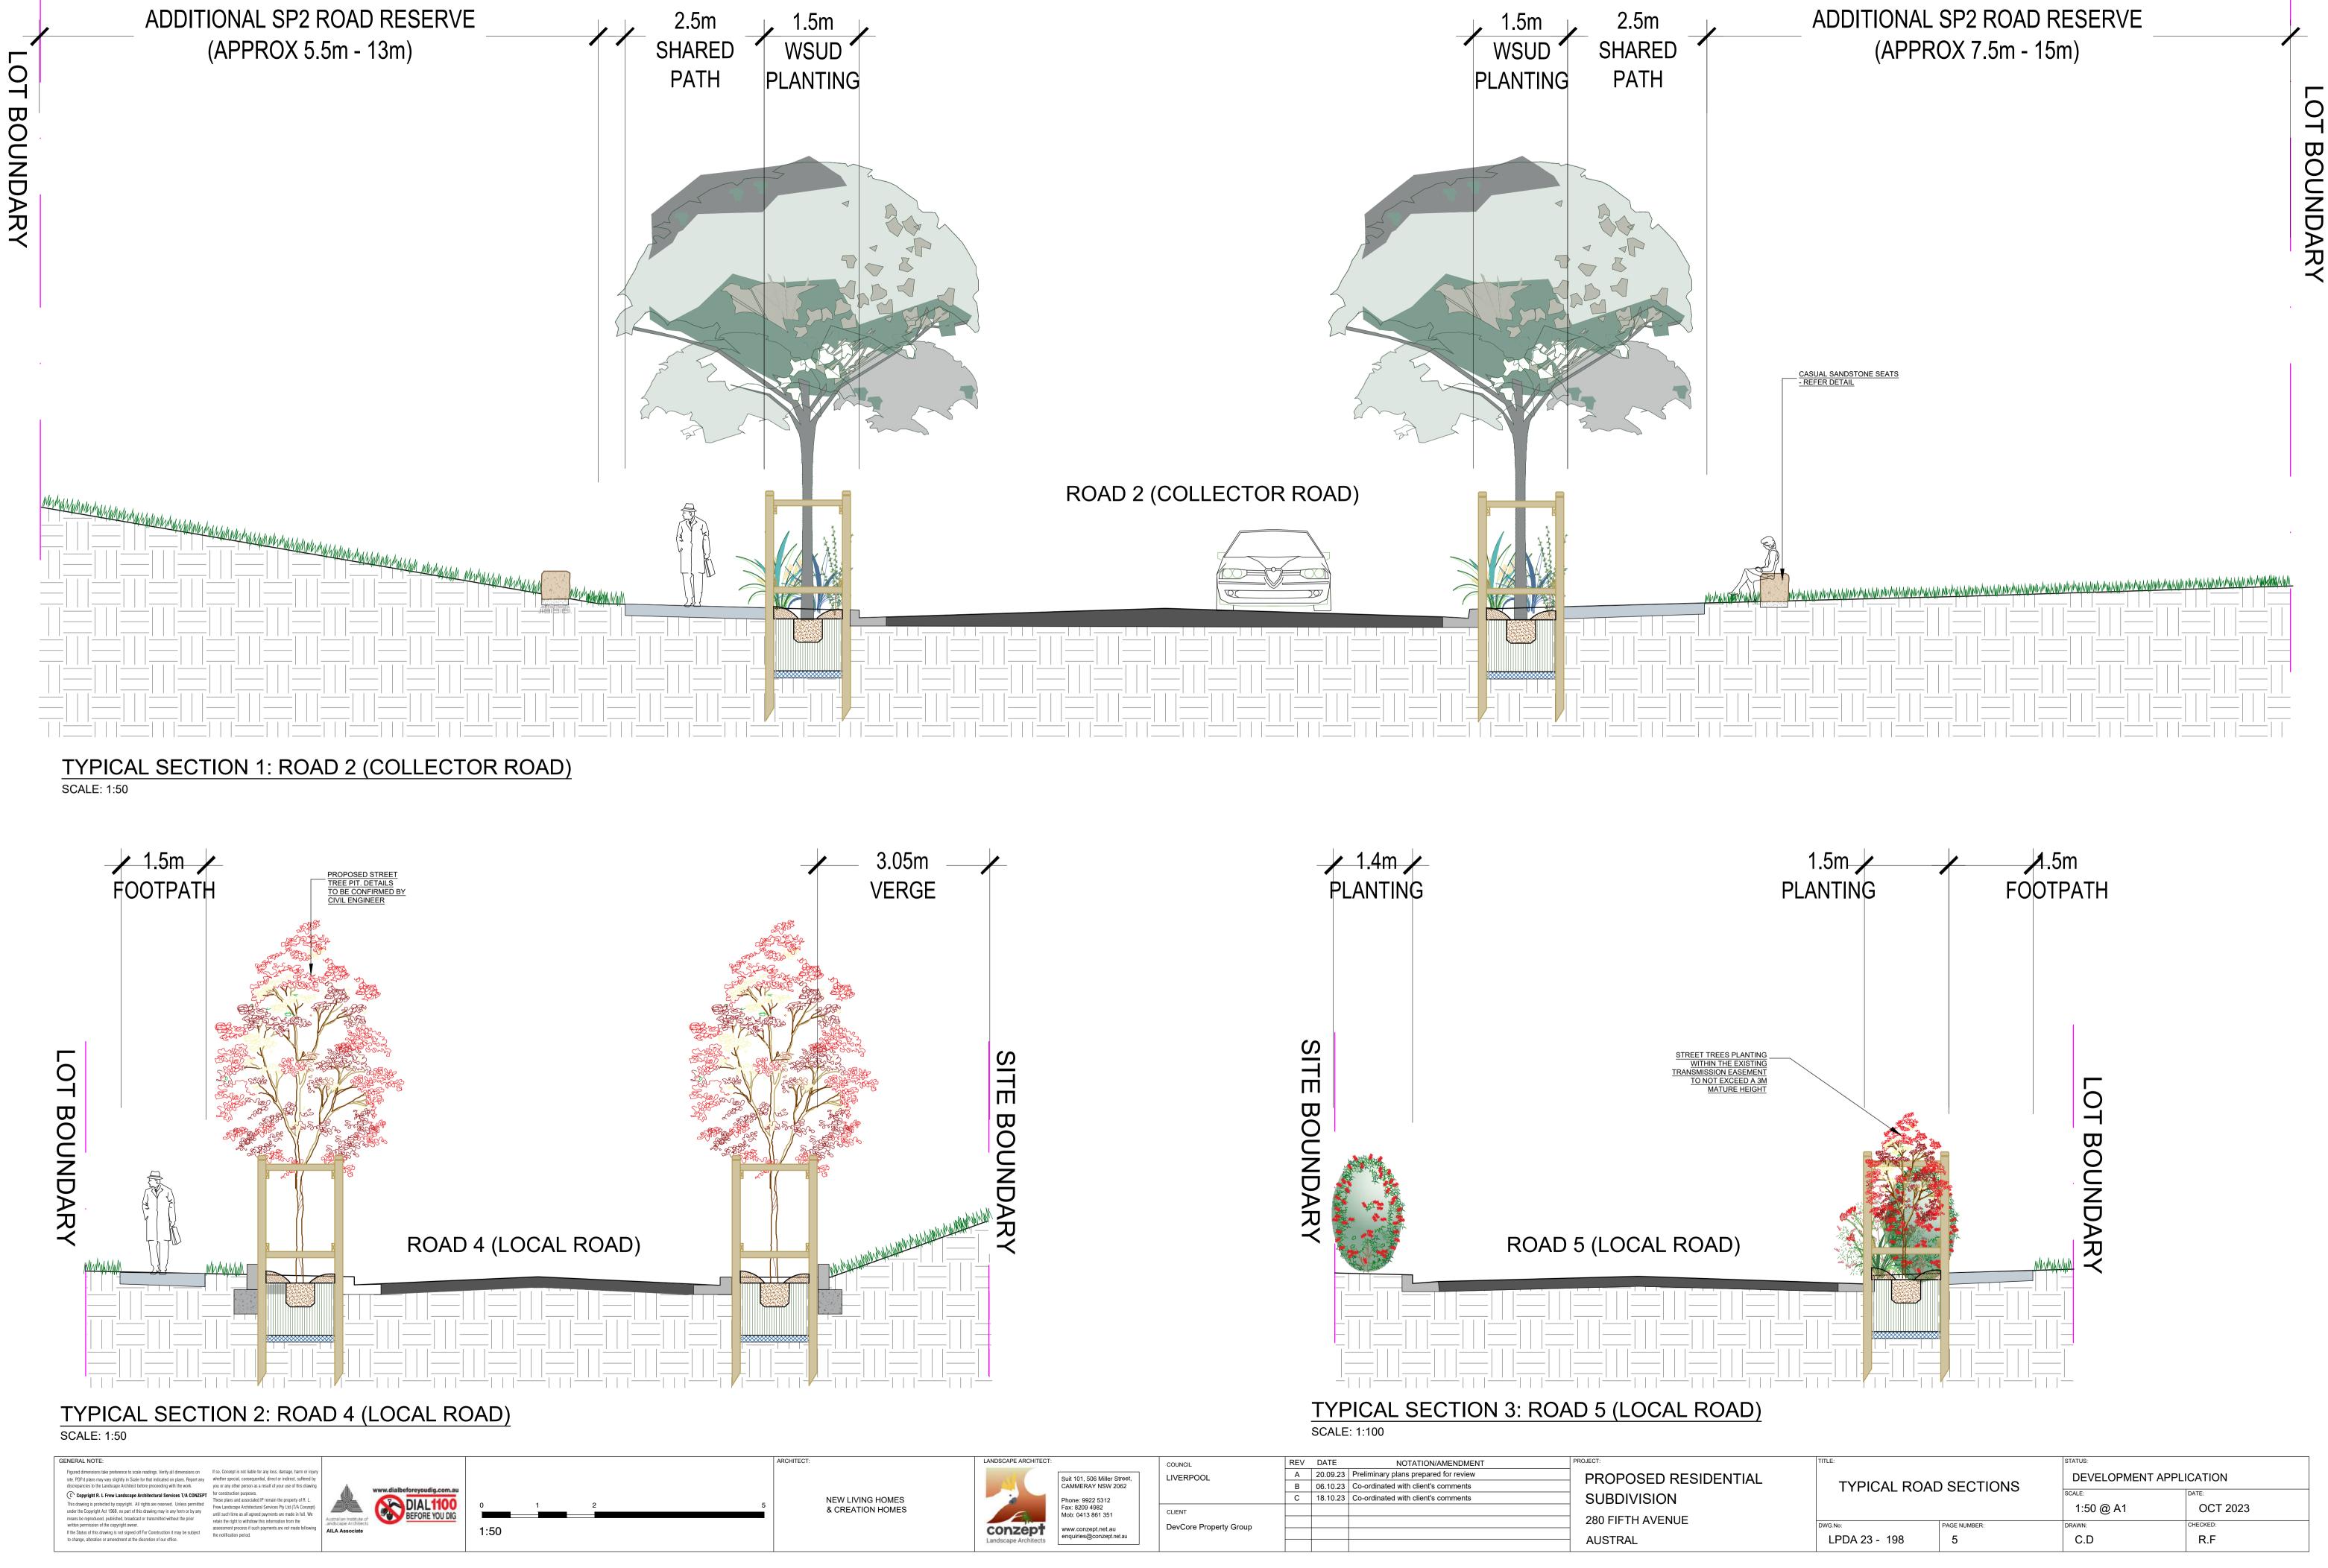PRELIMINARIES

1.01 GENERAL

The following general conditions should be considered prior to the commencement of landscape works The landscape plans should be read in conjunction with the architectural plans, hydraulic plans, service plans

- and survey prepared for the proposed development. All services including existing drainage should be accurately located prior to the commencement of landscape installation. Any proposed tree planting which falls close to services will be relocated on site under the instruction of the landscape architect.
- Installation of conduit for required irrigation, electrical and other services shall be completed prior to the commencement of hardscape works and hardstand pours.
- All outdoor lighting specified by architect or client to be installed by gualified electrician Anomalies that occur in these plans should be brought to our immediate attention
- Where an Australian Standard applies for any landscape material testing or installation technique, that standard shall be followed.

1.02 PROTECTION OF ADJACENT FINISHES

The Contractor shall take all precautions to prevent damage to all or any adjacent finishes by providing adequate protection to these areas / surfaces prior to the commencement of the Works

1.03 PROTECTION OF EXISTING TREES

Existing trees identified to be retained shall be done so in accordance with NATSPEC Guide 2 "A Guide to Assessing Tree Quality". Where general works are occurring around such trees, or pruning is required, a qualified Arborist shall be engaged to oversee such works and manage tree health. Existing trees designated on the drawing for retention shall be protected at all times during the construction period. Any soil within the drip-line of existing trees shall be excavated and removed by hand only. No stockpiling shall occur within the root zone of existing trees to be retained.

Any roots larger in diameter than 50mm shall only be severed under instruction by a qualified arborist. Roots smaller than 50mm diameter shall be cut cleanly with a saw.

Temporary fencing shall be installed around the base of all trees to be retained prior to the commencement of landscape works. Where possible this fencing will be located around the drip line of these trees, or a minimum of 3m from the trunk.

The fencing shall be maintained for the full construction period.

1.04 EROSION & POLLUTION CONTROL

The Contractor shall take all proper precautions to prevent the erosion of soil from the subject site. The contractor shall install erosion & sediment control barriers and as required by council, and maintain these barriers throughout the construction period. Note that the sediment control measures adopted should reflect the soil type and erosion characteristics of the site.

Erosion & pollution control measures shall incorporate the following:

- Construction of a sediment trap at the vehicle access point to the subject site - Sediment fencing using a geotextile filter fabric in the location indicated on the erosion control plan or as instructed on

site by the landscape archited - Earth banks to prevent scour of stockpiles

Sandbag kerb sediment traps

- Straw bale & geotextile sediment filter - Exposed banks shall be pegged with an approved Jute matting in preparation for mass planting

Refer to "Sitewise Reference Kit" as prepared by DLWC & WSROC (1997) for construction techniques

SOIL WORKS

2.01 MATERIALS

Specified Soil Conditioner (Generally to improve site soil) The specified soil conditioner for site top-soil improvement shall be an organic mix, equal to "Botany Humus", as supplied by ANL. Note that for sites where soil testing indicates toxins or extremes in pH, or soils that are extremely poor, allow to excavate and supply 300mm of imported soil mix.

New gardens & proposed Planting

New garden and planting areas shall consist of a 50/50 mix of clean site soil (refer d) below) and imported "Organic Garden Mix" as supplied by ANL or approved equal. All mixes are to comply with AS 4419 Soils for landscaping & garden use, & AS 4454 Composts, Soil conditioners & mulches

Specified Soil Mix - Turf

The specified soil mix for all turf areas shall be a min 75mm layer of imported soil mix consisting of 80% washed river sand (reasonably coarse), and 20% composted organic matter equivalent to mushroom compost or soil conditioner, or other approved lawn top dress

Site Topsoil

Site topsoil is to be clean and free of unwanted matter such as gravel, clay lumps, grass, weeds, tree roots, sticks, rubbish and plastics, and any deleterious materials and materials toxic to plants. The topsoil must have a pH of between 5.5 and 7. Use 100% imported soil mix when site when site topsoil runs out.

2.02 INSTALLATION

a) Testing

All testing is to be conducted in accordance with AS 1289 Methods for testing soils for engineering purposes. Site soil shall be given a pH test prior to modifying to ensure conditions are appropriate for planting as stated above. Tests shall be taken in several areas where planting is proposed, and the pH shall be adjusted accordingly with sulphur or lime to suit.

Note that a soil test conducted by the "Sydney Soil Lab" or approved equal shall be prepared for all commercial, industrial and multi-unit residential sites. The successful landscape contractor shall implement the recommendations of this test.

b) Set Out of Individual Trees & Mass Planting Areas

All individual tree planting positions and areas designated for mass planting shall be set out with stakes or another form of marking, ready for inspection and approval. Locate all services.

c) Establishing Subgrade Levels

Subgrade levels are defined as the finished base levels prior to the placement of the specified material (i.e. soil conditioner). The following subgrade levels shall apply:

Mass Planting Beds - 300mm below existing levels with specified imported soil mix.

 Turf areas - 100mm below finished surface level. Note that all subgrades shall consist of a relatively free draining natural material, consisting of site topsoil placed previously by the Civil Contractor. No builders waste material shall be acceptable.

d) Subgrade Cultivation

Cultivate all subgrades to a minimum depth of 100mm in all planting beds and all turf areas. ensuring a thorough breakup of the subgrade into a reasonably coarse tilth. Grade subgrades to provide falls to surface and subsurface drains, prior to the placement of the final specified soil mix.

e) Drainage Works

Install surface and subsurface drainage where required and as detailed on the drawing. Drain subsurface drains to outlets provided, with a minimum fall of 1:100 to outlets and / or service pits.

f) Placement and Preparation of Specified Soil Conditioner & Mixes. Trees in turf & beds - Holes shall be twice as wide as root ball and minimum 100mm deeper - backfill hole with

50/50 mix of clean site soil and imported "Organic Garden Mix" as supplied by ANL or approved equal. Mass Planting Beds - Install specified soil conditioner to a compacted depth of 100mm

Place the specified soil conditioner to the required compacted depth and use a rotary hoe to thoroughly mix the conditioner into the top 300mm of garden bed soil. Ensure thorough mixing and the preparation of a reasonably fine tilth and good growing medium in preparation for planting. Turf Areas - Install specified soil mix to a minimum compacted depth of 75mm.

Place the specified soil mix to the required compacted depth and grade to required finished soil levels, in preparation for planting and turfing.

PLANTING

3.01 MATERIALS

a) Quality and Size of Plant Material

All trees supplied above a 25L container size must be grown and planted in accordance with Clarke, R 1996 Purchasing Landscape Trees: A guide to assessing tree quality. Natspec Guide No. 2. Certification that trees have been grown to Natspec guidelines is to be provided upon request of Council's Tree Management Officer. Above - Ground Assessment:

The following plant quality assessment criteria should be followed:

Plant true to type, Good vigour and health, free from pest & disease, free from injury, self-supporting, good stem taper, has been pruned correctly, is apically dominant, has even crown symmetry, free from included bark & stem junctions, even trunk position in pot, good stem structure

Below - Ground Assessment: Good root division & direction, rootball occupancy, rootball depth, height of crown, non-suckering For further explanation and description of these assessment criteria, refer to Ross Clark's book.

All Plant material shall be to the type and size specified. No substitutions of plant material shall be permitted without written prior approval by the Landscape Architect. No plant shall be accepted which does not conform to the standards listed above.


b) Stakes and Ties

Provide min. 3 No. Stakes and ties to all plants identified as trees in the plant schedule. Stakes shall be sound, unpainted, straight hardwood, free of knots and pointed at one end. They shall be 2200mm x 50mm x 50mm Hardwood, or approved alternative. Ties shall be 50mm wide hessian webbing material.

GENERAL NOTE

red dimensions take preference to scale readings. Verify all dimensions on If so, Conzept is not liable for any loss, damage, harm or inju site. PDF'd plans may vary slightly in Scale for that indicated on plans. Report any discrepancies to the Landscape Architect before proceeding with the work. This drawing is protected by copyright. All rights are reserved. Unless permitted under the Copyright Act 1968, no part of this drawing may in any form or by any means be reproduced, published, broadcast or transmitted without the prior written permission of the copyright owner. C Copyright R. L Frew Landscape Architectural Services T/A CONZEPT for construction purposes.

If the Status of this drawing is not signed off For Construction it may be subject to change, alteration or amendment at the discretion of our office

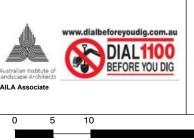

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c) Fertiliser

Fertilisers shall be approved slow release fertilisers suitable for the proposed planting types. Note that for native plants specifically Proteaceae family plants including Grevillea species, low phosphorus fertilizers shall be used. d) Mulch

Mulch shall be an approved equal to "Forest Blend" as supplied by ANL. Mulch shall be completely free from any soil, weeds, rubbish or other debris. e) Turf

Turf shall be "Sir Walter" Buffalo or equivalent (unless stated otherwise), free from any weeds and other grasses, and be in a healthy growing condition.

3.02 INSTALLATION a) Setting Out

All planting set out shall be in strict accordance with the drawings, or as directed. Note that proposed tree planting located near services should be adjusted at this stage. Notify Landscape Architect for inspection for approval prior to planting

b) Planting

All plant material shall be planted as soon after delivery as possible. Planting holes for trees shall be excavated as detailed and specified. Plant containers shall be removed and discarded, and the outer roots gently teased from the soil mass. Immediately set plant in hole and backfill with specified soil mix, incorporating the approved quantity of fertiliser for each plant type. Ensure that plants are set plumb vertically and root balls set to the consolidated finished grades detailed on the drawings. Compact the backfilled soil and saturate by hand watering to expel any remaining air pockets immediately after planting.

c) Staking and Tying

Staking and tying shall be in strict accordance with the drawings and shall occur immediately following plant placement and soil backfilling. All plants identified as "Trees" on the planting schedule shall be staked with a min. 3 stakes.

d) Mulching Mulch should be spread so that a compacted thickness of 75mm is achieved after settlement in all planting beds and around each individual plant. Apply immediately following planting and watering in, ensuring that a 50mm radius is maintained around the trunk of each plant . There shall be no mixing of soil and mulch material.

e) Turfing

Noisten soil prior to the turf being laid. Turf shall be neatly butt jointed and true to grade to finish flush with adjacent surfaces. Incorporate a lawn fertilizer and thoroughly water in. Keep turf moist until roots have taken and sods/rolls cannot be lifted. Keep all traffic off turf until this has occurred. Allow for top dressing of all turf areas. All turf shall be rolled immediately following installation.

f) Timber edging

The Contractor shall install timber edging as detailed on the drawings, to all mass planting beds adjoining turf or gravel mulched areas, and where required. The resultant edge shall be true to line and flush with adjacent surfaces. HARDSCAPE WORKS

4.01 GENERAL

The Contractor shall undertake the installation of all hardscape works as detailed on the drawing, or where not detailed, by manufacturers specification. • Paving - refer to typical details provided, and applicable Australian Standards. Permeable paving may be used

as a suitable means of satisfying Council permeable surface requirements, while providing a useable, hardwearing, practical surface. In most instances, the client shall nominate the appropriate paving material to be used. Australian Standards shall be adhered to in relation to all concrete, masonry & metal work. Some details are typical and

may vary on site. All hardscape works shall be setout as per the drawings, and inspected and approved by the Landscape Architect prior to installation. All workmanship shall be of the highest standard. Any queries or problems that arise from hardscape variations should be bought to the attention of the Landscape Architect. Your attention is directed to any obligations or responsibilities under the Dividing Fences Act, 1991 in respect of adjoining property owner/s which may arise from this application. Any enquiries in this regard may be made to the Crown Lands Division on (02) 8836 5332

IRRIGATION WORKS

5.01 GENERAL (PERFORMANCE SPECIFICATION)

New irrigation systems to planting areas shall be a Commercial Grade Irrigation System conforming to all relevant Australian standards, including AS 3500 & the Electrical Safety Act 2002, Workplace Health & Safety Act 1995, & the latest Svdnev Water Code

An automated drip-irrigation system is to be installed to all gardens, planters and lawn areas in accordance with the approved Irrigation Design

This system shall be designed and installed by a qualified and licensed irrigation specialist, to the highest industry

standards and to maximise the efficient usage of water. The Installer is required to obtain all approvals necessary for the completion of works in accordance with the Laws of Australia, Laws of the State of NSW, Blacktown Council By-Laws and Ordinances.

Drawings

- The Landscape Contractor nominated Licensed Irrigation Specialist shall provide irrigation drawings for approval upon engagement.

Design Requirements:

- The irrigation system shall be installed prior to all planting works. It shall incorporate a commercially available irrigatior system, with sub-surface dripper lines to irrigate all gardens, planters and lawn areas. - It shall incorporate a suitable back flow prevention device for the scale of works, an in-line filter. check valves. and suitable high and low density poly hose fittings and PVC piping to achieve flow rates suitable for specified planting. The irrigation application rate shall not exceed the infiltration rate of the soil or creates run-off - The landscape contractor shall check the existing pressure available from the ring mains and size irrigation piping to

suit. Supply shall be from local hose cock where available.

- All piping and fittings shall be buried 50mm below the finished soil levels in garden and lawn areas, and secured in position at 500mm centres with galv wire pins - Size of pipes shall be selected to ensure the working pressure at the end of the line does not decrease by more than

5%

Services Co-ordination: - Co-ordination required by Landscape Contractor or Project Manager to provide required conduit, pipe work and

Upon completion of installation, the system shall be tested, including:

- A full 12 month warranty shall be included to cover labour and all parts.

- On request, a detailed irrigation performance specification report can be issued.

This shall include, but not be limited to, the following items where and as required:

• Mowing lawns & trimming edges each 14 days in summer or 18 days in winter

superintendent or landscape architect, the responsibility will be signed over to the client.

Watering all planting and lawn areas / irrigation maintenance

• Maintenance of all paving, retaining and hardscape elements.

• Clearing litter and other debris from landscaped areas. Removing weeds, pruning and general plant maintenance.

Replacement of damaged, stolen or unhealthy plants.

Make good areas of soil subsidence or erosion

• Spray / treatment for Insect and disease control.

Fertilizing with approved fertilizers at correct rates.

Topping up of mulched areas.

Adjusting ties to Stakes

power provision and water supply.

over a determined length of time.

Testing & Defects:

exceed 300Kpa.

Warranty :

6.01 GENERAL

immediately rectified.

Further Documentation:

CONSOLIDATION AND MAINTENANCE

penetration through slabs and planter walls for water and power provisions. - The Landscape Contractor shall be engaged with the Irrigation Specialist to co-ordinate with the Project Manager to identify the preferred service and conduit locations.

- Project Manager and Landscape Contractor to establish area suitable for irrigation control system with required area,

- Main Line Pressure Test: The main line is pressurised to test for leaks. All valves are shut and the pressure is taken

- Dripper Pressure Test: Measurement at flushing valves are taken and the pressure gauged to make sure it conforms to

the manufacturer recommendations. The inlet pressure is then tested under the same conditions to check it does not

- All components are to be satisfactorily functional and operational prior to approval. Should any defect develop, or the

The consolidation and maintenance period shall be 12 months beginning from the approved completion of the specified construction work (Practical Completion). A gualified landscape maintenance contractor shall undertake the required


works by accepted landscaping or horticultural practices, ensuring that all plants are in optimum growing conditions and


landscape maintenance works. Consolidation and maintenance shall mean the care and maintenance of Contracted

On the completion of the maintenance period, the landscape works shall be inspected and at the satisfaction of the


appearance at all times, as well as rectifying any defects that become apparent in the contracted works.

capacity or efficiency of the system decline during the agreed maintenance system, then these faults shall be

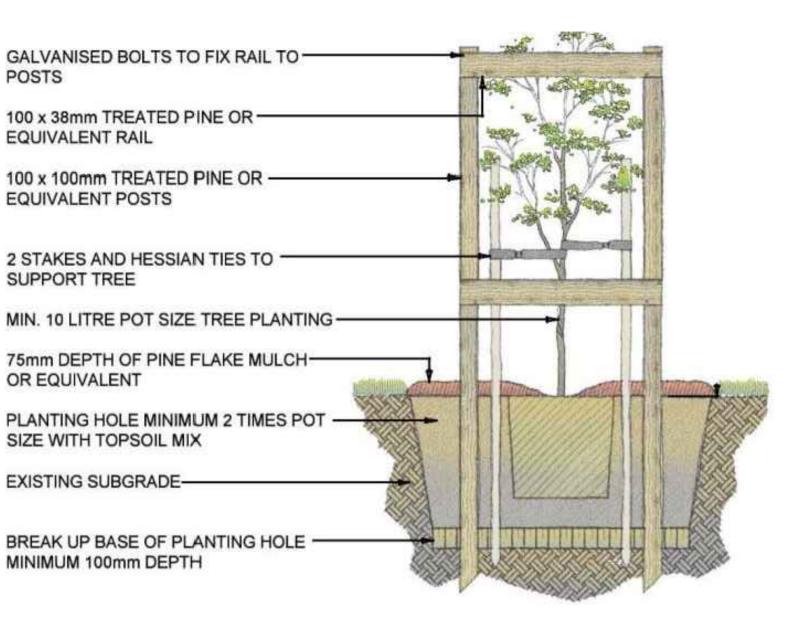

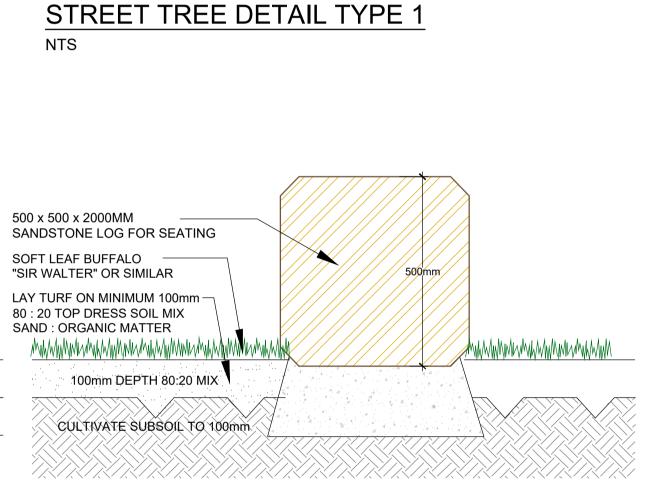

TURF & SANDSTONE SEATING LOG SCALE: 1:10

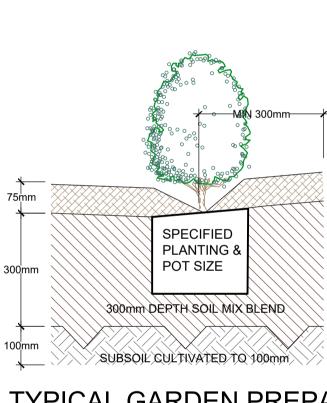

SCALE 1:10

NOTE: DRIP IRRIGATION MAY BE

REQUIRED AS NOMINATED BY

STOCK SHALL BE SOURCED

LICENSED CONTRACTOR. PLANT

FROM GROWERS CONFORMING

'SPECIFYING TREES' BY ROSS

CLARKE. THOROUGHLY WATER

IN ALL NEWLY PLANTED STOCK

IMMEDIATELY AFTER PLANTING.

RE-CYCLED PLASTIC -

TO STREET TREES

TURF TO NATURE STRIP

NTS

ROOT CONTROL BARRIER


OF HOLE (MIN 100mm) TO

PROMOTE ROOT GROWTH

CULTIVATE / BREAK-UP BASE-

CLIENT & DESIGNED BY

TO NAT SPEC. GUIDE

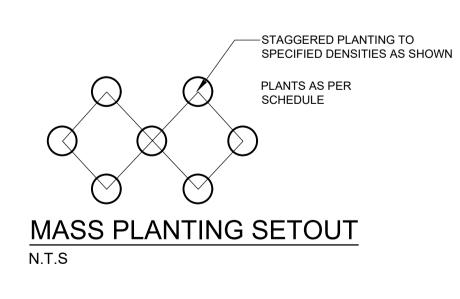

www.conze



	COUNCIL
Suit 101, 506 Miller Street, CAMMERAY NSW 2062	LIVER
Phone: 9922 5312	
Fax: 8209 4982 Mob: 0413 861 351	CLIENT
www.conzept.net.au enquiries@conzept.net.au	DevCo


RPOOL ore Property Group

	REV	REV DATE NOTATION/AMENDMENT A 20.09.23 Preliminary plans prepared for review	
	А		
B 06.10.23 Co-ordinated with client's comments		Co-ordinated with client's comments	
C 18.10.23 Co-ordinated with client's comme		18.10.23	Co-ordinated with client's comments

PROPOSED RESIDENTIAL SUBDIVISION 280 FIFTH AVENUE AUSTRAL



100mm

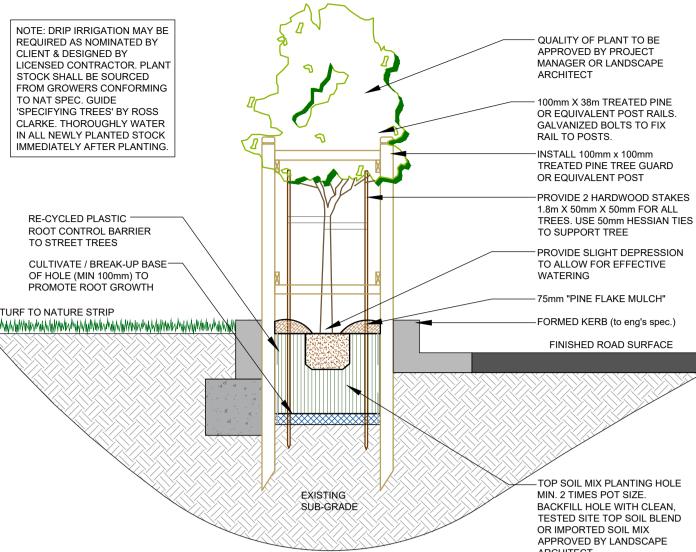

STREET TREE DETAIL TYPE 2

ARCHITECT.

CONDITIONER/ COMPOSTED **ORGANIC MATTER - SEE SPEC** USE 100% IMPORTED SOIL MIX WHEN SITE TOPSOIL CULTIVATED TO 100mm WHEN SITE TOPSOIL RUNS OUT

TYPICAL SETBACK FROM

MULCH OR EQUIVALENT

SOIL MIX:

75mm DEPTH "FOREST BLEND"

FREE FROM ALL BUILDER'S

RUBBISH AND DELETERIOUS

GARDEN MIX OR SOIL

50% OF STOCKPILED SITE TOPSOIL

MATERIALS. TOPSOIL TO BE MIXED

WITH MINIMUM 50% IMPORTED

LAWN/GARDEN EDGE

TYPICAL GARDEN PREPARATION DETAIL

SPECIFICATIONS & DETAILS			
		AS SHOWN @A1	DATE: OCT 2023
DWG.No:	PAGE NUMBER:	DRAWN:	CHECKED:
LPDA 23 - 198	6	C.D	R.F



crest Enterprises (T/A Conzept) until such time as all agreed payments a nese plans and a nade in full. We retain the right b notification period. ament process if such payments are not made following th



1:500

DA - ISSUE D



DRAWING SCHEDULE

LANDSCAPE PLAN NOTES

This plan should be read in conjunction with the This plan should be fead in conjunction with the architectural and hydraulics plans. Work specific to these plans should be prepared in accordance to these plans, including specification and details prior to the installation of landscaping, and should not be altered or compromised during landscape construction. Elements such as drainage swales may be incorporated in garden bed areas (using non-floatable mulch) without compromising the capacity or form.

This plan has been prepared for Development Application approval only, not for construction


This plan has been prepared with reference to *LIVERPOOL COUNCIL* Landscaping Guidelines & requirements. Planting proposed using mainly indigenous, commercially available plant species selected from local planting lists and the BASIX local plant list and from Sydney Waters "Plant

Selector"web site one-drip rated native plants (acceptable for BASIX planting).

The Design & location of new letter boxes shall be in accordance with Australia Post's "Requirements for Delivery of Mail to Residential Premises" published Feb '97. All noxious weeds listed in Councils weed lists & located on the site shall be continually removed & suppressed. Reinstate all boundary fencing in poor condition with Council approved 1.8m fencing to rear of building line, rake to 1m forward of BL. Pollution, sediment & erosion control devices as specified shall be in place, and maintained for the duration of the construction period. Proposed excavation near existing established trees to be supervised by arborist.

LIVERPOOL approved landscape plan's are required to be constructed as approved to obtain occupancy certificate. Permeable areas may be indicated to achieve site coverage restrictions & should be constructed as drawn on this plan.

	TITLE:	DWG.No:	
et,	MASTER PLAN	LPDA 23-235 / 1	
		DATE:	
312 2 351	PROPOSED RESIDENTIAL SUBDIVISION	NOV 2023	
	280 FIFTH AVE	DRAWN:	CHECKED:
net.au izept.net.au	AUSTRAL	C.D/L.Z	R.F

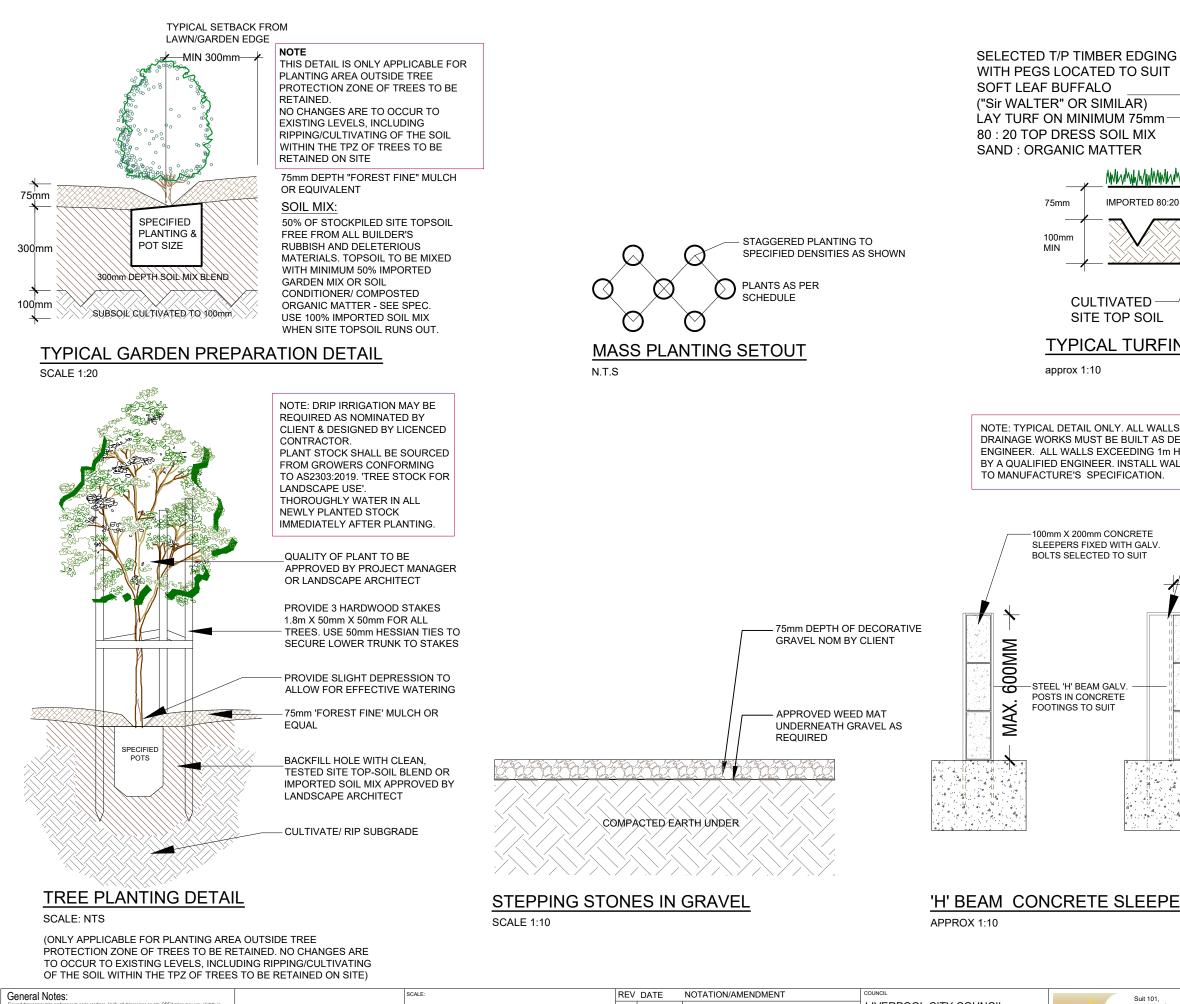

I	Scale for that indicated on plans. Report any discrepancies to the Landscape Architect before proceeding with the work.
I	Copyright Sulphurcrest Enterprises Pty Ltd Trading as CONZEPT
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	This drawing is protected by copyright. All rights are reserved. Unless permitted under the Copyright Act 1968, no part of this drawing may in may form or by any means be reproduced, published, broadcast or transmitted without the prior written permission of the copyright owner.
I	If the Status of this drawing is not signed off For Construction it may be subject to change, alteration or amendment at the discretion of
I	our office. If so, Conzept is not liable for any loss, damage, harm or injury whether special, consequential, direct or indirect, suffered by
I	you or any other person as a result of your use of this drawing for construction purposes.
I	These plans and associated IP remain the property of Sulphurcrest Enterprises (T/A Conzept) until such time as all agreed payments are



AS SHOWN @ A3

REV	DATE	NOTATION/AMENDMENT	COUNCIL	Suit 101.	TITLE:	DWG.No:	
Α	31.03.202	3 For submission	LIVERPOOL CITY COUNCIL	506 Miller Street, CAMMERAY		LPDA 23	3-235 / 2
В	20.09.202	3 Coordinated with site plan updates		NSW 2062	DETAILS		
С	25.10.202	3 Coordinated with site plan updates	CLIENT			DATE:	
D	01.11.202	3 Coordinated with site plan updates	NEW LIVING HOMES	Phone: 9922 5312	PROPOSED RESIDENTIAL	NOV	/ 2023
				Fax: 8209 4982 Mob: 0413 861 351	SUBDIVISION		
			STATUS / ISSUE	CONTON	280 FIFTH AVE	DRAWN:	CHECKED:
			DA - ISSUE D	conzept www.conzept.net.au	AUSTRAL	C.D/L.Z	R.F
				Landscape Architects enquiries@conzept.net.au			

75mm

100mm

approx 1:10

100mm X 200mm CONCRETE

BOLTS SELECTED TO SUIT

STEEL 'H' BEAM GALV.

POSTS IN CONCRETE


FOOTINGS TO SUIT

SLEEPERS FIXED WITH GALV.

CULTIVATED

SITE TOP SOIL

MIN

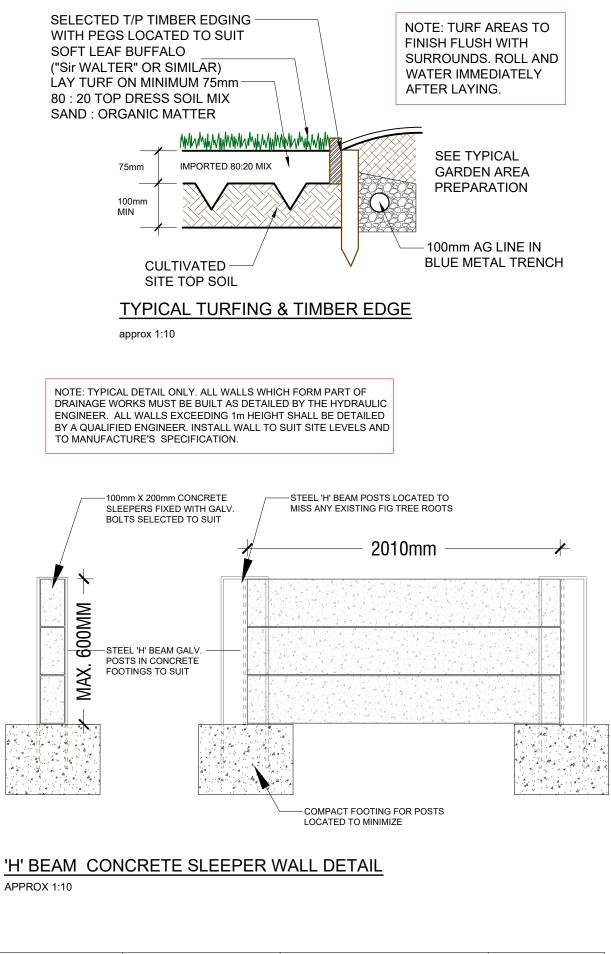


SAMPLE IMAGES

Images are for design intent only, final planting species may vary, as determined by Council Approval



Elaeocarpus reticulatus



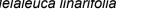



Magnolia 'Little Gem'



Banksia integrifolia



Waterhousia floribunda



Syzygium 'Resilience'







Photinia 'Red Robin'



Acmena smithii 'Minor'





Callistemon 'White Anzac'




Phormium tenax 'Purpureum'



Doryanthes excelsa





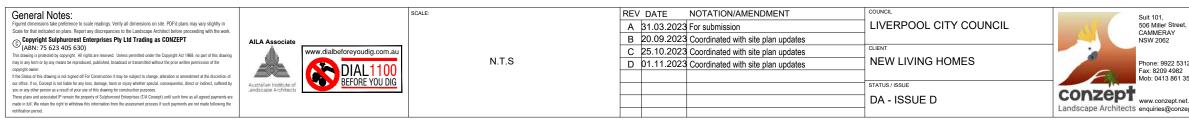

Westringia 'Aussie Box'







Backhousia myrtifolia



Callistemon 'BetterJohn'



Casuarina 'Cousin It'

	TITLE:	DWG.No:	
et,	PLANTING PALETTES	LPDA 23	-235/3
		DATE:	
312 2 351	PROPOSED RESIDENTIAL SUBDIVISION	NOV	2023
	280 FIFTH AVE	DRAWN:	CHECKED:
net.au izept.net.au	AUSTRAL	C.D/L.Z	R.F

PRELIMINARIES

1.01 GENERAL

The following general conditions should be considered prior to the commencement of landscape works:

- The landscape plans should be read in conjunction with the architectural plans, hydraulic plans, service plans and survey prepared for the proposed development All services including existing drainage should be accurately located prior to the commencement of landscape installation. Any proposed
- tree planting which falls close to services will be relocated on site under the instruction of the landscape architect. Installation of conduit for required irrigation, electrical and other services shall be completed prior to the commencement of hardscape
- works and hardstand pours All outdoor lighting specified by architect or client to be installed by qualified electrician
- Anomalies that occur in these plans should be brought to our immediate attention. Where an Australian Standard applies for any landscape material testing or installation technique, that standard shall be followed.

1.02 PROTECTION OF ADJACENT FINISHES

The Contractor shall take all precautions to prevent damage to all or any adjacent finishes by providing adequate protection to these areas / surfaces prior to the commencement of the Works

1.03 PROTECTION OF EXISTING TREES

Existing trees identified to be retained shall be done so in accordance with AS 4970-2009 Protection of trees on development sites as well as in accordance with the tree protection measures prepared by project arborist

Where general works are occurring around such trees, or pruning is required, a qualified Arborist shall be engaged to oversee such works and manage tree health.

Existing trees designated on the drawing for retention shall be protected at all times during the construction period. Any soil within the drip-line of existing trees shall be excavated and removed by hand only. No stockpiling shall occur within the root zone of existing trees to be retained.

Any roots larger in diameter than 50mm shall only be severed under instruction by a qualified arborist. Roots smaller than 50mm diameter shall be cut cleanly with a saw.

Temporary fencing shall be installed around the base of all trees to be retained prior to the commencement of landscape works. Where possible this fencing will be located around the drip line of these trees, or a minimum of 3m from the trunk. The fencing shall be maintained for the full construction period.

1.04 EROSION & POLLUTION CONTROL

The Contractor shall take all proper precautions to prevent the erosion of soil from the subject site. The contractor shall install erosion & sediment control barriers and as required by council, and maintain these barriers throughout the construction period. Note that the sediment control measures adopted should reflect the soil type and erosion characteristics of the site.

Erosion & pollution control measures shall incorporate the following:

- Construction of a sediment trap at the vehicle access point to the subject site. Sediment fencing using a geotextile filter fabric in the location indicated on the erosion control plan or as instructed on site by the landscape architect.
- Earth banks to prevent scour of stockpiles
- Sandbag kerb sediment traps
- Straw bale & geotextile sediment filter
- Exposed banks shall be pegged with an approved Jute matting in preparation for mass planting

Refer to 'Guidelines for Erosion and Sediment Control on Building Sites' by DLWC (2000) for construction techniques

SOIL WORKS

2.01 MATERIALS

Specified Soil Conditioner (Generally to improve site soil)

The specified soil conditioner for site top-soil improvement shall be an organic mix complies with AS 4454-2012 Composts, soil conditioners and mulches. Note that for sites where soil testing indicates toxins or extremes in pH, or soils that are extremely poor, allow to excavate and supply 300mm of imported soil mix.

New gardens & proposed Planting

New garden and planting areas shall consist of a 50/50 mix of clean site soil (refer d) below) and imported soil. All mixes are to comply with AS4419-2003 Soils for Landscaping and garden use, & AS 4454 Composts, Soil conditioners & mulches

Specified Soil Mix - Turf

The specified soil mix for all turf areas shall be a min 75mm layer of imported soil mix consisting of 80% washed river sand (reasonably coarse), and 20% composted organic matter equivalent to mushroom compost or soil conditioner, or other approved lawn top dress.

Site Topsoi

Site topsoil is to be clean and free of unwanted matter such as gravel, clay lumps, grass, weeds, tree roots, sticks, rubbish and plastics, and any deleterious materials and materials toxic to plants. The topsoil must have a pH of between 5.5 and 7. Use 100% imported soil mix when site when site topsoil runs out.

2.02 INSTALLATION

General Notes:

Note: No level changes (Cut or Fill), soil ripping within the Tree Protection Zones of trees to be retained

a) Testing

All testing is to be conducted in accordance with AS4419-2003 Soils for Landscaping and garden use Methods for testing soils for engineering purposes. Site soil shall be given a pH test prior to modifying to ensure conditions are appropriate for planting as stated above. Tests shall be taken in several areas where planting is proposed, and the pH shall be adjusted accordingly with sulphur or lime to suit

Note that a soil test conducted by the Sydney Environmental & Soil Laboratory or approved equal shall be prepared for all commercial industrial and multi-unit residential sites. The successful landscape contractor shall implement the recom ndations of this test

b) Set Out of Individual Trees & Mass Planting Areas

All individual tree planting positions and areas designated for mass planting shall be set out with stakes or another form of marking, ready for inspection and approval. Locate all services.

Establishing Subgrade Levels

ale for that indicated on plans. Report any discrepancies to the Landscape A

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If the Status of this drawing is not signed off For Construction it may be subject to change, alteration or amendment at the disc

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Subgrade levels are defined as the finished base levels prior to the placement of the specified material (i.e. soil conditioner). The following subgrade levels shall apply: • Mass Planting Beds - 300mm below existing levels with specified imported soil mix.

AILA Associa

to scale readings. Verify all dimensions on site. PDF'd plans may vary slightly in

Turf areas - 100mm below finished surface level. Note that all subgrades shall consist of a relatively free draining natural material, consisting of site topsoil placed previously by the Civil

ding with the work

Contractor. No builders waste material shall be acceptable

Subgrade Cultivation

Cultivate all subgrades to a minimum depth of 100mm in all planting beds and all turf areas, ensuring a thorough breakup of the subgrade into a reasonably coarse tilth. Grade subgrades to provide falls to surface and subsurface drains, prior to the placement of the final specified soil mix.

Drainage Works

Install surface and subsurface drainage where required and as detailed on the drawing. Drain subsurface drains to outlets provided, with a minimum fall of 1:100 to outlets and / or service pits

- Placement and Preparation of Specified Soil Conditioner & Mixes. Trees in turf & beds Holes shall be twice as wide as root ball and minimum 100mm deeper backfill hole with 50/50 mix of clean site soil and imported "Organic Garden Mix" as supplied by ANL or approved equal. Mass Planting Beds - Install specified soil conditioner to a compacted depth of 100mm
- Place the specified soil conditioner to the required compacted depth and use a rotary hoe to thoroughly mix the conditioner into the top 300mm

bed soil. Ensure thorough mixing and the preparation of a reasonably fine tilth and good growing medium in preparation for planting. Turf Areas - Install specified soil mix to a minimum compacted depth of 75mm.

Place the specified soil mix to the required compacted depth and grade to required finished soil levels, in preparation for planting and turfing

PLANTING

3.01 MATERIALS

a) Quality and Size of Plant Material

All trees supplied above a 25L container size must be grown and planted in accordance with AS 2303:2019 Tree stock for landscape use. Certification that trees have been grown to AS2303:2018 guidelines is to be provided upon request of Council's Tree Management Officer

Above - Ground Assessment:

ity assessment criteria should be followed:

Plant true to type, Good vigour and health, free from pest & disease, free from injury, self-supporting, good stem taper, has been pruned correctly, is apically dominant, has even crown symmetry, free from included bark & stem junctions, even trunk position in pot, good stem structure

Below - Ground Assessment: Good root division & direction, rootball occupancy, rootball depth, height of crown, non-suckering For further explanation and description of these assessment criteria, refer to AS2303:2019.

All Plant material shall be to the type and size specified. No substitutions of plant material shall be permitted without written prior approval by the Landscape Architect. No plant shall be accepted which does not conform to the standards listed above

b) Stakes and Ties

Provide min. 3 No. Stakes and ties to all plants identified as trees in the plant schedule. Stakes shall be sound, unpainted, straight hardwood, free of knots and pointed at one end. They shall be 2200mm x 50mm x 50mm Hardwood, or approved alternative. Ties shall be 50mm wide hessian webbing material

Fertilisers

F, fertilisers shall be approved slow release fertilisers suitable for the proposed planting types. Note that for native plants, specifically Proteaceae family plants including Grevillea species, low phosphorus fertilizers shall be used.

Mulch

Mulch shall be an approved equal to "FOREST FINE" as supplied by ANL. Mulch shall be completely free from any soil, weeds, rubbish or other debris.

Turf

Turf shall be soft leaf Buffalo or equivalent (unless stated otherwise), free from any weeds and other grasses, and be in a healthy growing condition.

3.02 INSTALLATION

Setting Out

All planting set out shall be in strict accordance with the drawings, or as directed. Note that proposed tree planting located near services should be adjusted at this stage. Notify Landscape Architect for inspection for approval prior to planting.

Planting

All plant material shall be planted as soon after delivery as possible. Planting holes for trees shall be excavated as detailed and specified. Plant containers shall be removed and discarded, and the outer roots gently teased from the soil mass. Immediately set plant in hole and backfill with specified soil mix incorporating the approved quantity of fertiliser for each plant type. Ensure that plants are set plumb vertically and root balls set to the consolidated finished grades detailed on the drawings. Compact the backfilled soil and saturate by hand watering to expel any remaining air pockets immediately after planting.

c) Staking and Tying

Staking and tying shall be in strict accordance with the drawings and shall occur immediately following plant placement and soil backfilling. All plants identified as "Trees" on the planting schedule shall be staked with a min. 3 stakes.

Mulching

Mulch for general planter bed shall be an approved equal to "FOREST FINE" as supplied by ANL. Mulch shall be completely free from any soil, weeds, rubbish or other debris. Mulch for bio-retention/rain garden area where is required shall be non-floatable materials that could include crushed rock, gravel, coarse river sand, scoria or river pebbles. 4-7mm screenings or similar

e) Turfing

Moisten soil prior to the turf being laid. Turf shall be neatly butt jointed and true to grade to finish flush with adjacent surfaces. Incorporate a lawn fertilizer and thoroughly water in. Keep turf moist until roots have taken and sods/rolls cannot be lifted. Keep all traffic off turf until this has occurred. Allow for top dressing of all turf areas. All turf shall be rolled immediately following installation

Timber edaina

Where is required, the Contractor shall install Timber edging as detailed on the drawings, to all mass planting beds adjoining turf or gravel mulched areas, and where required. The resultant edge shall be true to line and flush with adjacent surfaces. However, no edging shall be used within the Structural Root Zone (SRZ) of trees to be retained.

Nature Strip and public domain works

The nature strip (street frontage) for the site is public land, and only authorized works may occur here. Existing Conditions such as street trees, council planting etc shall be retained and protected during construction, unless specific approval has been granted for new work in this area. Where council policy specifies a particular unit paver, material finish, pattern or treatment, it shall be the contractors responsibility to check and verify that this material & treatment is correct and current prior to undertaking construction works

Drainage pit

N.T.S

SCALE:

/ww.dialbeforeyoudig.com.a

DIAL1100 BEFORE YOU DIG

BEFORE YOU DIG

Drainage pits and drainage lines should be located within garden areas to allow for site drainage while minimising impact on the proposed planting scheme. where possible, pits and linework should be located at the edge of landscape strips to avoid precluding planting centrally in garden areas. where pits and linework occur within garden beds, the landscape contractor shall take all precautions to avoid damaging storm water when planting shrubs and trees. landscape contractors shall not alter the form of swales designed to direct overland flow

REV DATE NOTATION/AMENDMENT

B 20.09.2023 Coordinated with site plan updates

C 25.10.2023 Coordinated with site plan updates

D 01.11.2023 Coordinated with site plan updates

A 31.03.2023 For submission

4.01 GENERAL

specification.

shall nominate the appropriate paying material to be used

the Landscape Architect.

IRRIGATION WORKS

efficient usage of water

Design Requirements:

centres with galv wire pins

service and conduit loca

water supply.

length of time.

6.01 GENERAL

Adius

LIVERPOOL CITY COUNCIL

NEW LIVING HOMES

STATUS / ISSUE

DA - ISSUE D

from local hose cock where available

CONSOLIDATION AND MAINTENANCE

Topping up of mulched areas.

ting ties to Stake

conzept

andscape Architects enquiries@conz

Suit 101, 506 Miller Stree CAMMERAY

ne: 9922.53

5.01 GENERAL (PERFORMANCE SPECIFICATION)

building contractual arrangements. on terraces, over slabs and in Communal Open Spaces. determined by the building contract

The Contractor shall undertake the installation of all hardscape works as detailed on the drawing, or where not detailed, by manufacturers

Paving - refer to typical details provided, and applicable Australian Standards. Permeable paving may be used as a suitable means of satisfying Council permeable surface requirements, while providing a useable, hardwearing, practical surface. In most instances, the client

Australian Standards shall be adhered to in relation to all concrete, masonry & metal work. Some details are typical and may vary on site. All hardscape works shall be setout as per the drawings, and inspected and approved by the Landscape Architect prior to installation. All workmanship shall be of the highest standard. Any queries or problems that arise from hardscape variations should be bought to the attention of

Your attention is directed to any obligations or responsibilities under the Dividing Fences Act. 1991 in respect of adjoining property owner/s which may arise from this application. Any enquiries in this regard may be made to the Crown Lands on 1300 886 235

This is a general Irrigation Performance Specification only, as a guide for projects requiring irrigation systems as part of consent requirements or

An automated irrigation system is recommended for the effective establishment of new gardens, and to assist with the success of planting areas

The inclusion of this general specification is no guarantee that an irrigation system forms part of the landscape scope of works, which will be

New irrigation systems to planting areas shall be a Commercial Grade Irrigation System conforming to all relevant Australian standards, including AS 3500 & the Gas and Electricity (Consumer Safety) Act 2017, Workplace Health & Safety Act 2011, & the latest Sydney Water Code

An automated drip-irrigation system is to be installed to all gardens, planters and lawn areas in accordance with the approved Irrigation Design. This system shall be designed and installed by a qualified and licensed irrigation specialist, to the highest industry standards and to maxin

Drawings: - The Landscape Contractor nominated Licensed Irrigation Specialist shall provide irrigation drawings for approval upon engagement.

The irrigation system shall be installed prior to all planting works. It shall incorporate a commercially available irrigation system, with sub-surface dripper lines to irrigate all gardens, planters and lawn areas. - It shall incorporate a suitable back flow prevention device for the scale of works, an in-line filter, check valves, and suitable high and low

density poly hose fittings and PVC piping to achieve flow rates suitable for specified planting. - The irrigation application rate shall not exceed the infiltration rate of the soil or creates run-off.

The landscape contractor shall check the existing pressure available from the ring mains and size irrigation piping to suit. Supply shall be

All piping and fittings shall be buried 50mm below the finished soil levels in garden and lawn areas, and secured in position at 500mm

Size of pipes shall be selected to ensure the working pressure at the end of the line does not decrease by more than 5%.

Services Co-ordination: - Co-ordination required by Landscape Contractor or Project Manager to provide required conduit, pipe work and penetration through slabs Co-ordination required by Landscape Cont and planter walls for water and power provisions. The Landscape Contractor shall be engaged with the Irrigation Specialist to co-ordinate with the Project Manager to identify the preferred

Project Manager and Landscape Contractor to establish area suitable for irrigation control system with required area, power provision and

 Testing & Defects:

 Upon completion of installation, the system shall be tested, including:

 Main Line Pressure Test: The main line is pressurised to test for leaks. All valves are shut and the pressure is taken over a determined

 Dripper Pressure Test: Measurement at flushing valves are taken and the pressure gauged to make sure it conforms to the manufacturer recommendations. The inlet pressure is then tested under the same conditions to check it does not exceed 300Kpa. All components are to be satisfactorily functional and operational prior to approval. Should any defect develop, or the capacity or efficiency of the system decline during the agreed maintenance system, then these faults shall be immediately rectified

 Warranty :

 A full 12 month warranty shall be included to cover labour and all parts.

<u>Further Documentation:</u> - On request, a detailed irrigation performance specification report can be issued

The consolidation and maintenance period shall be either

 6 months beginning from the approved completion of the specified construction work (Practical Completion) as agreed to in the landscape contractors contractual obligation

or as specified by Council in the Determination. A gualified landscape maintenance contractor shall undertake the required landscape maintenance works. Consolidation and maintenance shall mean the care and maintenance of Contracted works by accepted landscaping or horticultural practices, ensuring that all plants are in optimum growing conditions and appearance at all times, as well as rectifying any defects that become apparent in the contracted works.

This shall include, but not be limited to, the following items where and as required: Watering all planting and lawn areas / irrigation maintenance

Clearing litter and other debris from landscaped areas. Removing weeds, pruning and general plant maintenance

Replacement of damaged, stolen or unhealthy plants.


Make good areas of soil subsidence or erosion

Spray / treatment for Insect and disease control. Fertilizing with approved fertilizers at correct rates. Mowing lawns & trimming edges each 14 days in summer or 18 days in winter

Maintenance of all paving, retaining and hardscape elements.

On the completion of the maintenance period, the landscape works shall be inspected and at the satisfaction of the superintendent or landscape architect, the responsibility will be signed over to the client.

٦	TITLE:	DWG.No:		
	SPECIFICATION	LPDA 23	-235/4	
		DATE:		
	PROPOSED RESIDENTIAL	NOV	NOV 2023	
1	SUBDIVISION			
	280 FIFTH AVE	DRAWN:	CHECKED:	
au it.net.au	AUSTRAL	C.D/L.Z	R.F	

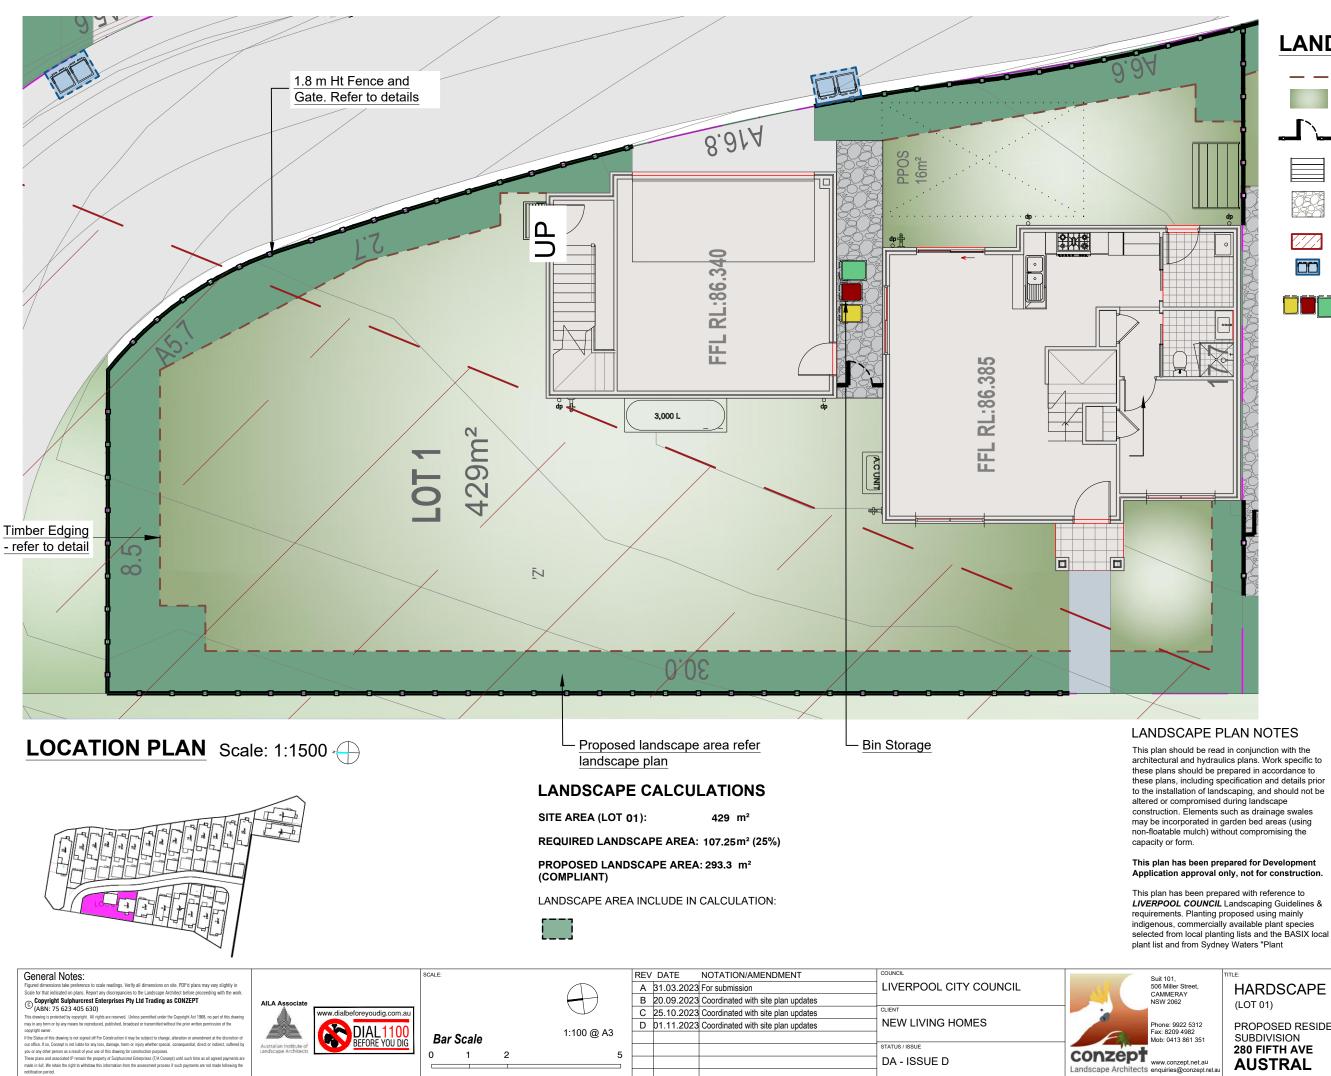

LANDSCAPE ITEMS



Timber Edging - refer detail

Turf area - refer detail



1.8m Gate and fence - colour and style to be nom. by client





Decorative gravel path

Existing Transmission Easement

Bin collection area

Bin storage area

Selector"web site one-drip rated native plants (acceptable for BASIX planting).

The Design & location of new letter boxes shall be in accordance with Australia Post's "Requirements for Delivery of Mail to Residential Premises" published Feb '97. All noxious weeds listed in Councils weed lists & located on the site shall be continually removed & suppressed. Reinstate all boundary fencing in poor condition with Council approved 1.8m fencing to rear of building line, rake to 1m forward of BL. Pollution, sediment & erosion control devices as specified shall be in place, and maintained for the duration of the construction period. Proposed excavation near existing established trees to be supervised by arborist.

LIVERPOOL approved landscape plan's are required to be constructed as approved to obtain occupancy certificate. Permeable areas may be indicated to achieve site coverage restrictions & should be constructed as drawn on this plan.

Street, AY 2	HARDSCAPE PLAN	DWG.No: LPDA 23-	-235/5
122 5312 4982 3 861 351	PROPOSED RESIDENTIAL SUBDIVISION	DATE: NOV	2023
zept.net.au @conzept.net.au	280 FIFTH AVE AUSTRAL	DRAWN: C.D/L.Z	CHECKED: R.F

NOTES

1. ALL FINAL PLANT QUANTITIES INDICATED ON PLANS SHALL BE CHECKED AND VERIFIED BY SUCCESSFUL LANDSCAPE CONTRACTOR. 2. ANY PLANT SUBSTITUTES REQUIRED DUE TO UNAVAILABILITY SHALL BE RECOMMENDED BY THE LANDSCAPE CONTRACTOR TO BEST MATCH SUBSTITUTED PLANTS AND APPROVED PRIOR TO PURCHASING BY THE LANDSCAPE ARCHITECT. 3. WORKS CERTIFIED FOR FINAL OCCUPANCY CERTIFICATE ARE TO MATCH

 APPROVED LANDSCAPE PLANS.
 ALANDSCAPE CONTRACTOR SHALL LOCATE AND AVOID SITE STORM WATER & DRAINAGE SERVICES. LOCATE TREES A MINIMUM 1.25M FROM PITS 5. ALL PLANTING AROUND EXISTING TREES SHALL BE ADJUSTED TO AVOID DAMAGE AND CLASHING WITH SURFACE ROOTS.

AND CLASHING WITH SURFACE ROOTS. 6. THE NATURE STRIP (STREET FRONTAGE) FOR THE SITE IS PUBLIC LAND, AND ONLY AUTHORIZED WORKS MAY OCCUR HERE. EXISTING CONDITIONS SUCH AS STREET TREES, COUNCIL PLANTING ETC SHALL BE RETAINED AND PROTECTED DURING CONSTRUCTION, UNLESS SPECIFIC APPROVAL HAS BEEN GRANTED FOR NEW WORK IN THIS AREA.

NEW WORK IN THIS AREA. 7. ALL TREES TO BE SOURCED IN ACCORDANCE WITH TESTS AND MEASUREMENTS CONTAINED WITHIN AS 2303-2015 - TREE STOCK FOR LANDSCAPE USE

TREES

Botanical Name: Callistemon citrinus Pot size:

Common Name: Lemon Bottlebrush(Native) 45Lt Mature H x S: 3.0m x 1.5-2m Qty Required: 1

Botanical Name: Waterhousia floribunda Common Name: Weeping Lilly Pilly (Native) Pot size: 75Lt Mature H x S: 10m x 6m Qty Required:

SHRUBS AND HEDGES

1



Botanical Name: Acmena smithii 'Minor' Common Name: Minor Lilly Pilly (Native) 200mm Mature H x S: 2-3m x 2m Qty Required: 23

Botanical Name: Rhaphiolepis indica Common Name: Indian Hawthorn (Exotic) 200mm Pot size: Mature H x S: Qty Required: 5

1.5m x 1.8m

Pot size: Mature H x S: Qty Required:

Botanical Name: Photinia 'Red Robin' Common Name: Red Robin Photinia (Exotic) 200mm 1.5-3m x 1.5-2.5m 15

Pot size:

Botanical Name: Callistemon 'Better John' **Common Name:** Better John Bottlebrush (Native) 200mm Mature H x S: 1m x 0.9m Qty Required: 9

FEATURE PLANTS



Botanical Name: Phormium tenax 'Purpureum' Common Name: New Zealand Flax (Exotic) Pot size: 300mm Mature H x S: 0.9m x 0.9m Qty Required: 1


GRASSES / GROUNDCOVERS

	Botanical Name:	Casuarina glau
3	Common Name:	Cousin It Casu
	Pot size:	140mm
1	Mature H x S:	0.1m x 1.5m
	Qty Required:	5/m2 (1 m2 tot

uca 'Cousin It' uarina (Native) otal)

Pot size: Mature H x S: Qty Required:


Botanical Name: Myoporum parvifolium 'Yareena' **Common Name:** Creeping Boobialla (Native) 140mm 0.15m x spreading 7/m2 (1.3m2 total)

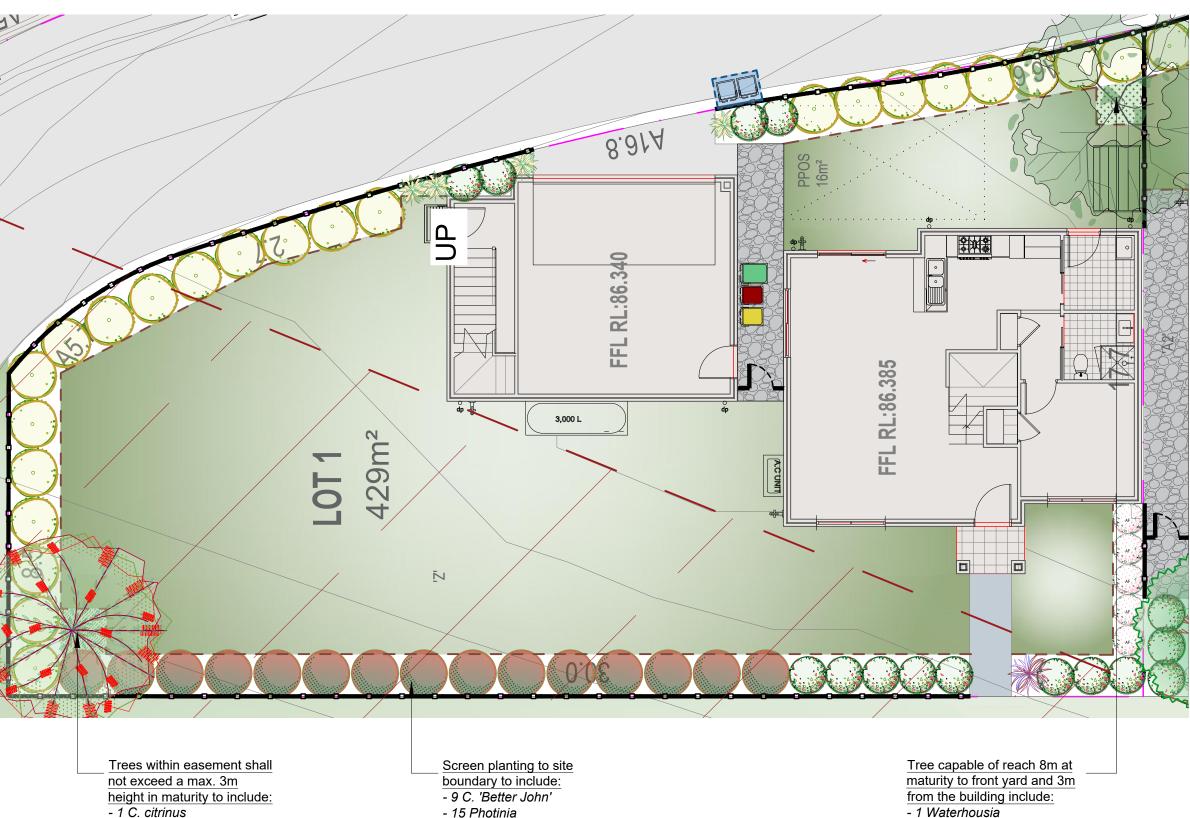

- 1m2 Casuarina

Botanical Name: Lomandra longifollia 'Tanika' **Common Name:** Dwarf Mat Rush (Native) Pot size: 150mm 0.8m x 0.8m Mature H x S: Qty Required: 4


- 23 Acmena
- 5 Rhaphiolepis
- 1 Phormium
- 4 Lomandra

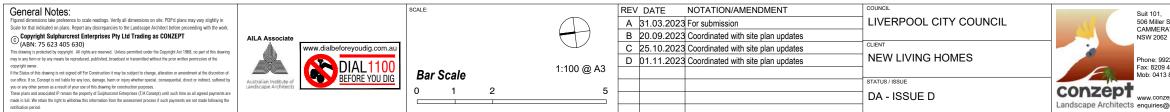


- 1.3m2 Myoporum

Refer to Liverpool Council DCP

	TITLE:	DWG.No:	
treet, Y	LANDSCAPE PLAN	LPDA 23-	235/6
		DATE:	
2 5312 982 861 351	PROPOSED RESIDENTIAL SUBDIVISION	NOV	2023
	280 FIFTH AVE	DRAWN:	CHECKED:
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LANDSCAPE PLAN NOTES

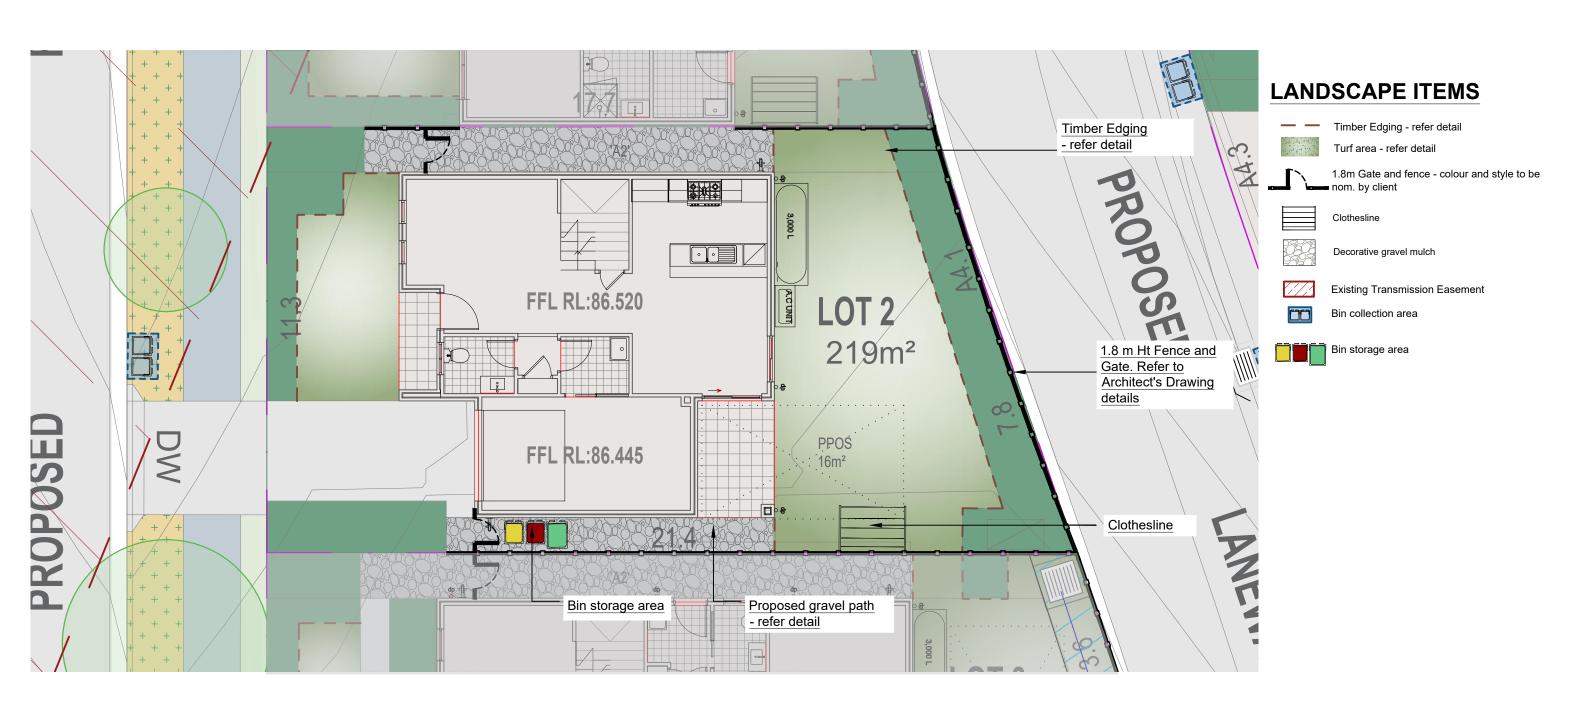This plan should be read in conjunction with the architectural and hydraulics plans. Work specific to the installation of landscaping, and should not be altered or compromised during landscape be incorporated in garden bed areas (using non-floatable mulch) without compromising the

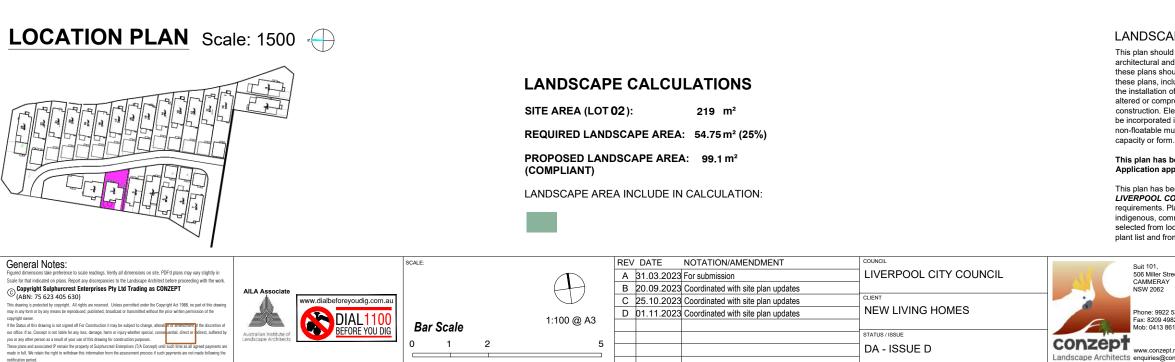This plan has been prepared for Development Application approval only, not for construction.

This plan has been prepared with reference to *LIVERPOOL COUNCIL* Landscaping Guidelines & requirements. Planting proposed using mainly indigenous, commercially available plant species

Selector"web site one-drip rated native plants (acceptable for BASIX planting).

The Design & location of new letter boxes shall be in these plans should be prepared in accordance to accordance with Australia Post's "Requirements for these plans, including specification and details prior topelivery of Mail to Residential Premises" published Feb '97. All noxious weeds listed in Councils weed altered or compromised during landscape lists & located on the site shall be continually removed construction. Elements such as drainage swales may & suppressed. Reinstate all boundary fencing in poor condition with Council approved 1.8m fencing to rear of building line, rake to 1m forward of BL. Pollution, sediment & erosion control devices as specified shall be in place, and maintained for the duration of the construction period. Proposed excavation near existing established trees to be supervised by arborist.

LIVERPOOL approved landscape plan's are required to be constructed as approved to obtain occupancy certificate. Permeable areas may be indicated to

 Indigenous, commercially available plant species
 Certificate. Fermetable a case may be a construction of the species

 selected from local planting lists and the BASIX local plant list and from Sydney Waters "Plant
 achieve site coverage restrictions & should be constructed as drawn on this plan.

	TITLE:	DWG.No:		
reet,	HARDSCAPE PLAN	LPDA 23-235 / 7		
	(LOT 02)	DATE:		
5312 82 61 351	PROPOSED RESIDENTIAL SUBDIVISION	NOV	2023	
	280 FIFTH AVE	DRAWN:	CHECKED:	
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NOTES: 1. ALL FINAL PLANT QUANTITIES INDICATED ON PLANS SHALL BE CHECKED AND VERIFIED BY SUCCESSFUL LANDSCAPE CONTRACTOR. 2. ANY PLANT SUBSTITUTES REQUIRED DUE TO UNAVAILABILITY SHALL BE RECOMMENDED BY THE LANDSCAPE CONTRACTOR TO BEST MATCH SUBSTITUTED

PLANTS AND APPROVED PRIOR TO PURCHASING BY THE LANDSCAPE ARCHITECT. 3. WORKS CERTIFIED FOR FINAL OCCUPANCY CERTIFICATE ARE TO MATCH APPROVED I ANDSCAPE PLANS.

4. LANDSCAPE CONTRACTOR SHALL LOCATE AND AVOID SITE STORM WATER & DRAINAGE SERVICES. LOCATE TREES A MINIMUM 1.25M FROM PITS 5. ALL PLANTING AROUND EXISTING TREES SHALL BE ADJUSTED TO AVOID DAMAGE

AND CLASHING WITH SURFACE ROOTS. 6. THE NATURE STRIP (STREET FRONTAGE) FOR THE SITE IS PUBLIC LAND, AND ONLY AUTHORIZED WORKS MAY OCCUR HERE. EXISTING CONDITIONS SUCH AS STREET TREES, COUNCIL PLANTING ETC SHALL BE RETAINED AND PROTECTED DURING CONSTRUCTION, UNLESS SPECIFIC APPROVAL HAS BEEN GRANTED FOR NEW WORK IN THIS AREA.

7. ALL TREES TO BE SOURCED IN ACCORDANCE WITH TESTS AND MEASUREMENTS CONTAINED WITHIN AS 2303-2015 - TREE STOCK FOR LANDSCAPE USE


TREES

Botanical Name: Melaleuca linarifolia Ste Pot size:

Common Name: Snow in Summer (Native) 75Lt Mature H x S: 8m x 4-6m Qty Required: 1

Botanical Name: Waterhousia floribunda **Common Name:** Weeping Lilly Pilly (Native) 75Lt Pot size: Mature H x S: 10m x 6m Qty Required: 1

SHRUBS AND HEDGES

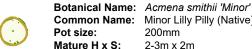

Common Name: Minor Lilly Pilly (Native) 200mm Pot size: Mature H x S: 2-3m x 2m Qty Required: 10 Botanical Name: Rhaphiolepis indica Common Name: Indian Hawthorn (Exotic) Pot size: 200mm 1.5m x 1.8m Mature H x S: Qty Required: 6

Botanical Name: Callistemon citrinus 'White Anzac' **Common Name:** Callistemon White Anzac (Native) 300mm Mature H x S: 1.4m x 2m Qty Required: 5

Botanical Name: Callistemon 'Better John' **Common Name:** Better John Bottlebrush (Native) Pot size: 200mm Mature H x S: 1m x 0.9m Qty Required: 3

Botanical Name: Doryanthes excelsa Common Name: Gymea Lily (Native) Pot size: 300mm Mature H x S: 1.1m x 1m Qty Required: 2

GRASSES / GROUNDCOVERS


Pot size:


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Botanical Name: Myoporum parvifolium 'Yareena' **Common Name:** Creeping Boobialla (Native) Pot size: 140mm Mature H x S: 0.15m x spreading 7/m2 (2.5m2 total) Qty Required:

	MA	_
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Botanical Name: Lomandra longifollia 'Tanika' **Common Name:** Dwarf Mat Rush (Native) Pot size: 150mm Mature H x S: 0.8m x 0.8m



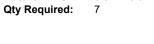


- 7 Lomandra

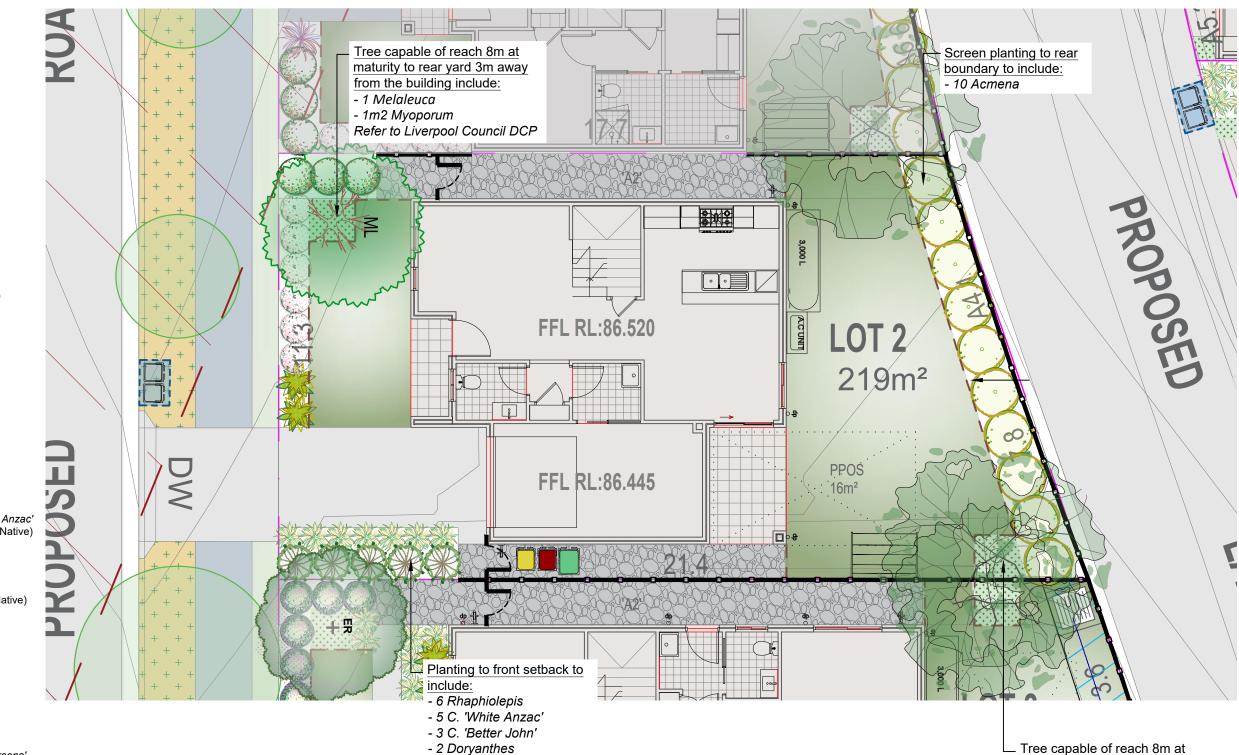REV DATE NOTATION/AMENDMENT SCALE General Notes: Suit 101 adings. Verify all dimensions on site. PDP'd plans may vary slightly LIVERPOOL CITY COUNCIL 506 Miller Stre A 31.03.2023 For submission cale for that indicated on plans. Report any discre CAMMERAY eding with the work B 20.09.2023 Coordinated with site plan updates C Copyright Sulphurcrest Enterprises Pty Ltd Trading as CONZEPT (ABN: 75 623 405 630) AILA w.dialbeforeyoudig.com.au C 25.10.2023 Coordinated with site plan updates NEW LIVING HOMES D 01.11.2023 Coordinated with site plan updates ne: 9922 DIAL1100 BEFORE YOU DIG 1:100 @ A3 Bar Scale x: 8209 498 b: 0413 86 The Statist or use comming is not asymptotic to construction in the property of solution in the property of solution in the property of solution is not as a result of your use of this drawing for construction purposes. These plans and associated IP remains the property of Solutionzest Enterprises (IV A Concept) until such time as all agreed payments and the solution of the solut conzept www.conzept 1 2 5 DA - ISSUE D Landscape Architects enquiries@co

maturity to rear yard 3m away from the building include: - 1 Waterhousia - 1.5m2 Myoporum Refer to Liverpool Council DCP

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et,		LPDA 23	-235/8
	(LOT 02)	DATE:	
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LANDSCAPE ITEMS

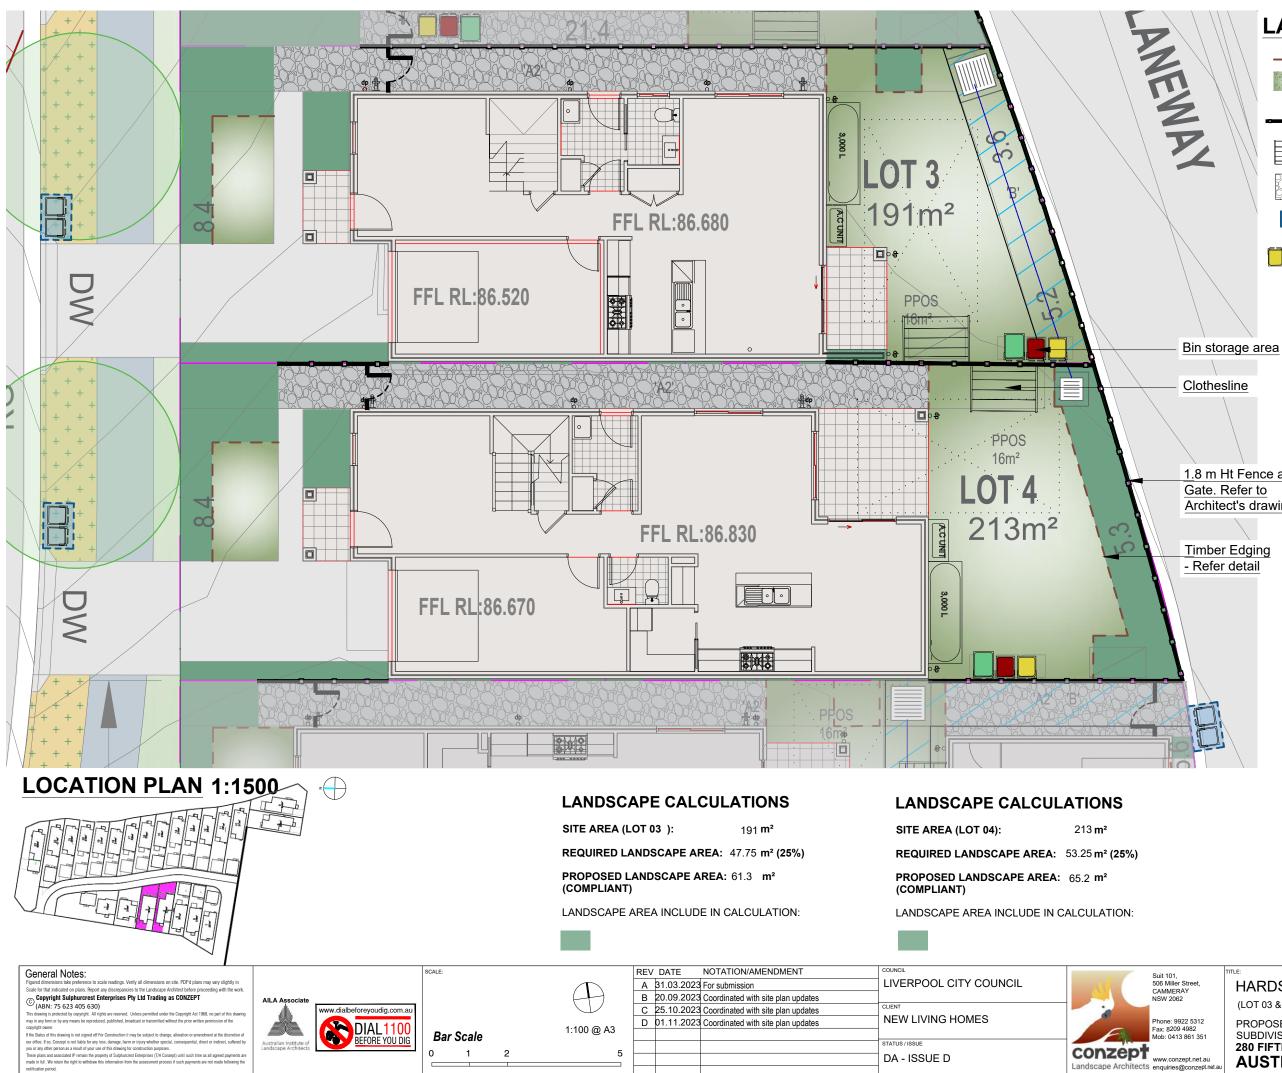

Timber Edging - refer detail

Turf area - refer detail

Clothesline

1.8m Gate and fence - colour and style to be nom. by client

Decorative gravel path

Bin collection area



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Bin storage area

1.8 m Ht Fence and Architect's drawing

	TITLE:	DWG.No:	
eet,	HARDSCAPE PLAN	LPDA 23-	-235 / 9
	(LOT 03 & 04)	DATE:	
5312 32 1 351	PROPOSED RESIDENTIAL SUBDIVISION	NOV	2023
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NOTES:

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NEW WORK IN THIS AREA. 7. ALL TREES TO BE SOURCED IN ACCORDANCE WITH TESTS AND MEASUREMENTS CONTAINED WITHIN AS 2303-2015 - TREE STOCK FOR LANDSCAPE USE

TREES

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Botanical Name:Melaleuca linarifoliaCommon Name:Snow in Summer (Native)Pot size:75LtMature H x S:8m x 4-6mQty Required:1

Botanical Name:Elaeocarpus reticulatusCommon Name:Blueberry Ash (Native)Pot size:75LtMature H x S:8-10m x 6-7mQty Required:1



Botanical Name:Waterhousia floribundaCommon Name:Weeping Lilly Pilly (Native)Pot size:75LtMature H x S:10m x 6mQty Required:2

SHRUBS AND HEDGES

ter .	

Botanical Name:Acmena smithii 'Minor'Common Name:Minor Lilly Pilly (Native)Pot size:200mmMature H x S:2-3m x 2mQty Required:6

Botanical Name:Westringia 'Aussie Box'Common Name:Westringia Aussie Box (Native)Pot size:200mmMature H x S:0.9m x 0.9mQty Required:7

Botanical Name:Callistemon 'Better John'Common Name:Better John Bottlebrush (Native)Pot size:200mmMature H x S:1m x 0.9mQty Required:7

FEATURE PLANTS



Botanical Name:Phormium tenax 'Purpureum'Common Name:New Zealand Flax (Exotic)Pot size:300mmMature H x S:0.9m x 0.9mQty Required:1





Botanical Name:Doryanthes excelsaCommon Name:Gymea Lily (Native)Pot size:300mmMature H x S:1.1m x 1mQty Required:5

GRASSES / GROUNDCOVERS



Botanical Name:Lomandra longifollia 'Tanika'Common Name:Dwarf Mat Rush (Native)Pot size:150mmMature H x S:0.8m x 0.8mQty Required:30

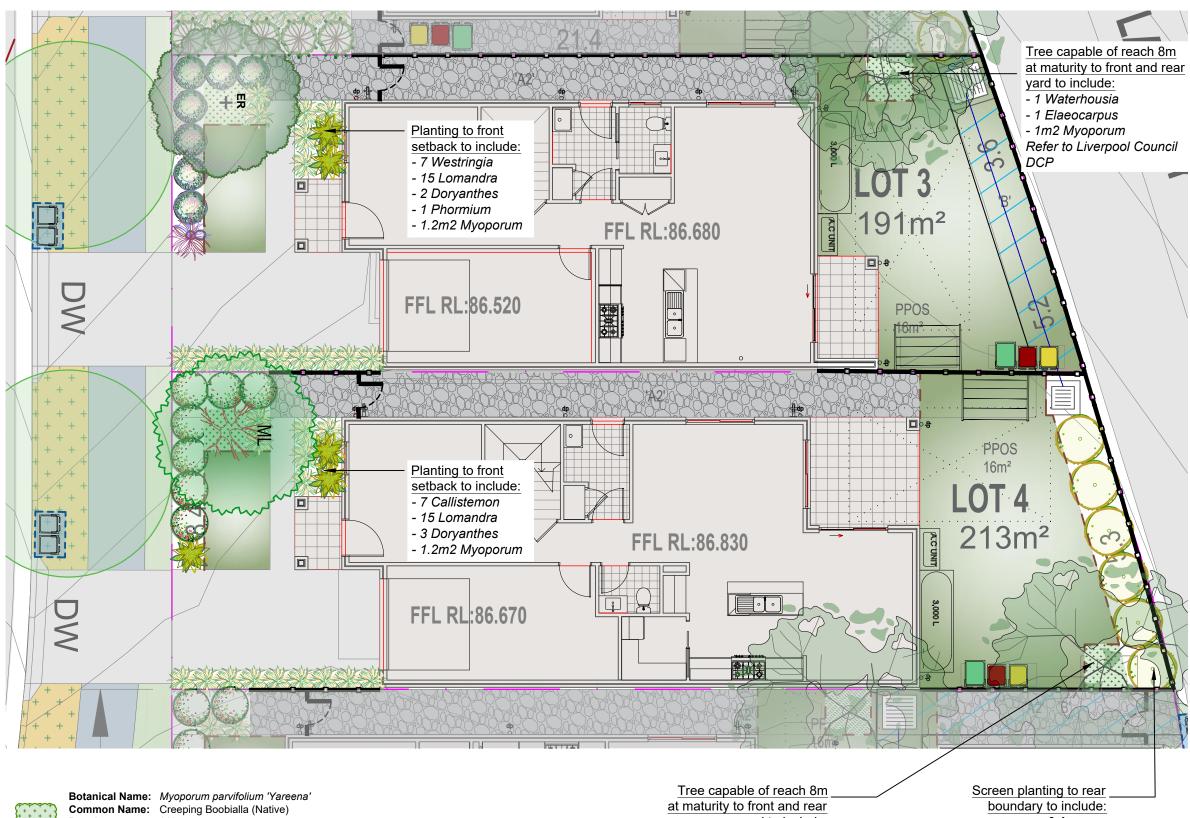

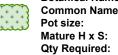


e: Myoporum parvifolium 'Yare e: Creeping Boobialla (Native) 140mm 0.15m x spreading 7/m2 (4.7m2 total) <u>at maturity to front and rear</u> <u>yard to include:</u> - 1 Melaleuca - 1 Waterhousia - 1.3m2 Myoporum Refer to Liverpool Council DCP

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made in full. We retain the right to withdraw this information from the assessment process if such payments are not made following the notification period.					DA - 1330E D	Landscape Architects enquiries@conze

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LANDSCAPE ITEMS



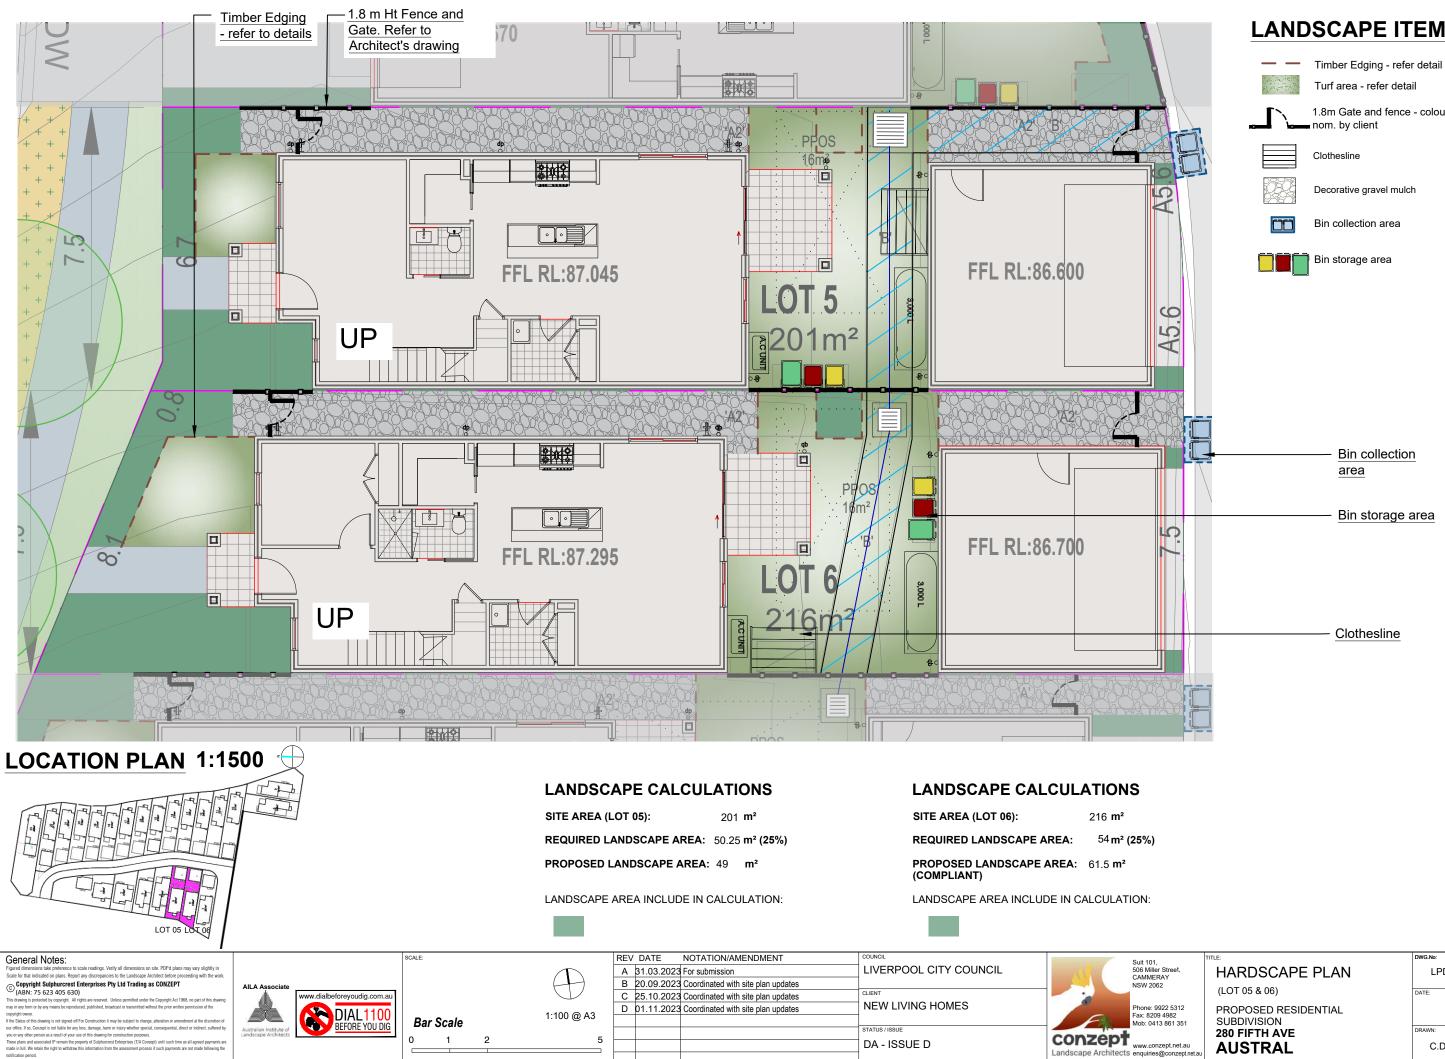

1.8m Gate and fence - colour and style to be







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	(LOT 05 & 06)	DATE:	
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1 351 net.au	SUBDIVISION 280 FIFTH AVE	DRAWN:	CHECKED:

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CONTAINED WITHIN AS 2303-2015 - TREE STOCK FOR LANDSCAPE USE

TREES

Botanical Name: Melaleuca linarifolia Pot size:

Common Name: Snow in Summer (Native) 75Lt Mature H x S: 8m x 4-6m Qty Required: 1

Botanical Name: Elaeocarpus reticulatus Pot size:

Common Name: Blueberry Ash (Native) 75Lt Mature H x S: 8-10m x 6-7m Qty Required: 1

Pot size: Qty Required:

Botanical Name: Waterhousia floribunda Common Name: Weeping Lilly Pilly (Native) 75Lt Mature H x S: 10m x 6m 2

SHRUBS AND HEDGES

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otanical Name: Westringia 'Aussie Box' ommon Name: Westringia Aussie Box (Native) ot size: 200mm Mature H x S: 0.9m x 0.9m Qty Required: 8

Botanical Name: Rhaphiolepis indica Common Name: Indian Hawthorn (Exotic) Pot size: 200mm Mature H x S: 1.5m x 1.8m Qty Required: 9

Botanical Name: Callistemon citrinus 'White Anzac' **Common Name:** Callistemon White Anzac (Native) Pot size: 300mm Mature H x S: 1.4m x 2m Qty Required: 4



Botanical Name: Callistemon 'Better John' Common Name: Better John Bottlebrush (Native) Pot size: 200mm Mature H x S: 1m x 0.9m Qty Required: 6

FEATURE PLANTS




Botanical Name: Phormium tenax 'Purpureum' Common Name: New Zealand Flax (Exotic) Pot size: 300mm Mature H x S: 0.9m x 0.9m Qty Required: 2



Botanical Name: Doryanthes excelsa **Common Name:** Gymea Lily (Native) Pot size: 300mm Mature H x S: 1.1m x 1m

2

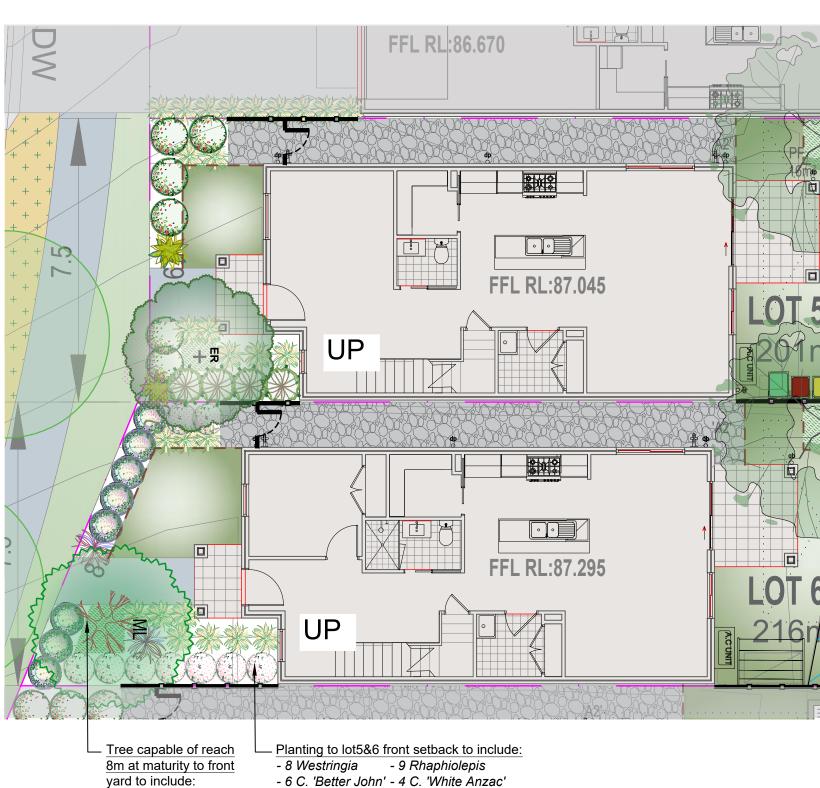

- yard to include:
- 1 Melaleuca - 1 Elaeocarpus
- Refer to Liverpool Council DCP


GRASSES / GROUNDCOVERS


- Botanical Name: Casuarina glauca 'Cousin It' Common Name: Cousin It Casuarina (Native) Pot size: 140mm Mature H x S: 0.1m x 1.5m Qty Required: 5/m2 (4.2 m2 total)

- 2 Doryanthes - 2 Phormium

- 2.2m2 Casuarina - 17 Lomandra


- Pot size: Mature H x S: Qty Required:
- Botanical Name: Lomandra longifollia 'Tanika' Common Name: Dwarf Mat Rush (Native) 150mm 0.8m x 0.8m 17

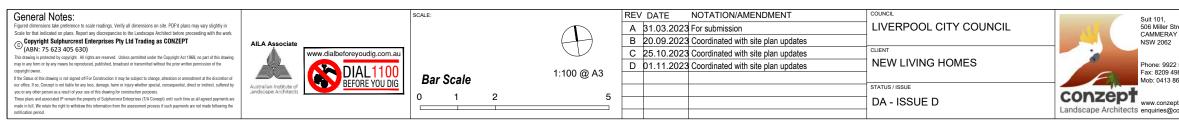

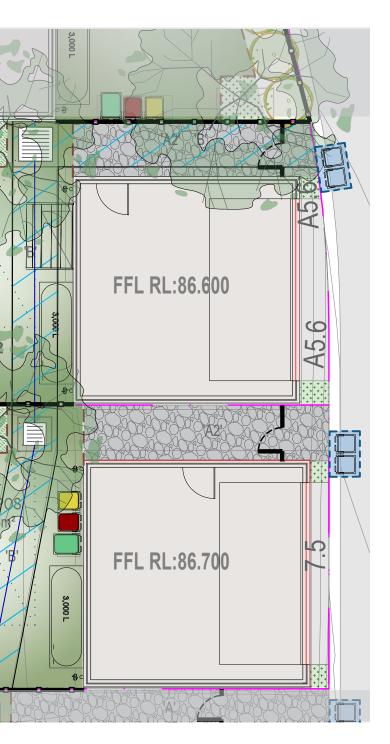

- Tree capable of reach 8m at maturity to rear yard to include: - 2 Waterhousia - 2m2 Casuarina Refer to Liverpool Council DCP

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LOCATION PLAN 1:1500

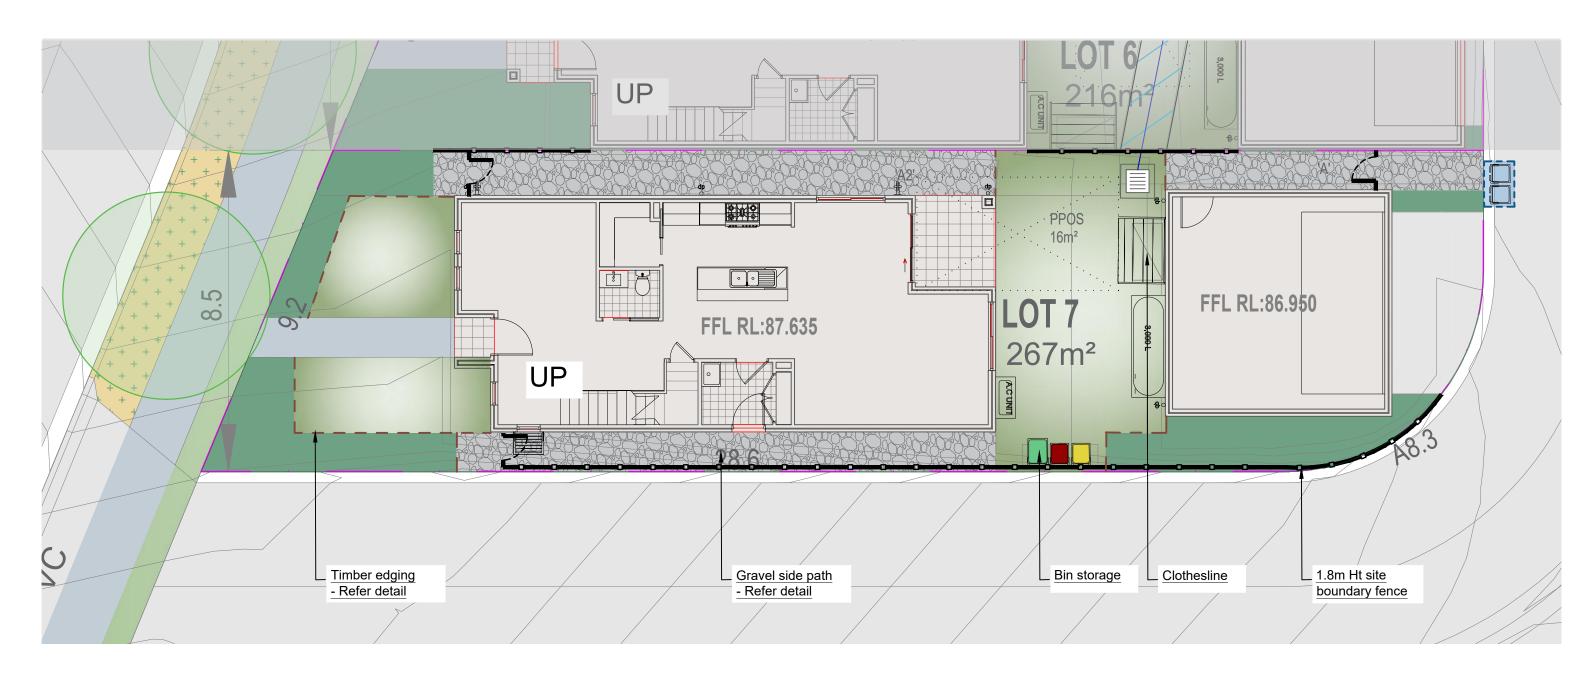

LANDSCAPE CALCULATIONS

SITE AREA (LOT 07): 267 m²

REQUIRED LANDSCAPE AREA: 66.75 m² (25%)

PROPOSED LANDSCAPE AREA: 86.3 m² (COMPLIANT)


LANDSCAPE AREA INCLUDE IN CALCULATION:





REV DATE NOTATION/AMENDMENT COUNCIL General Notes: SCALE Suit 101, 506 Miller Stre CAMMERAY NSW 2062 scale readings. Verify all dimensions on site. PDF'd plans may vary slightly in LIVERPOOL CITY COUNCIL A 31.03.2023 For submission Cale for that indicated on plans. Report any discrepancies to the Landscape Architect before proc Copyright Sulphurcrest Enterprises Pty Ltd Trading as CONZEPT (ABN: 75 623 4035 630) eding with the work B 20.09.2023 Coordinated with site plan updates AILA As C 25.10.2023 Coordinated with site plan updates www.dialbeforeyoudig.com.au NEW LIVING HOMES Phone: 9922 Fax: 8209 49 Mob: 0413 86 DIAL1100 BEFORE YOU DIG D 01.11.2023 Coordinated with site plan updates 1:100 @ A3 programs wanted for the status of the status Bar Scale STATUS / ISSUE Australian Institute Landscape Architects enquiries@cc 1 2 5 DA - ISSUE D ade in full. We retain the right ment process if such payments are not made following th on from the ass ication period.

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treet, Y	HARDSCAPE PLAN	LPDA 23	
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General Notes:
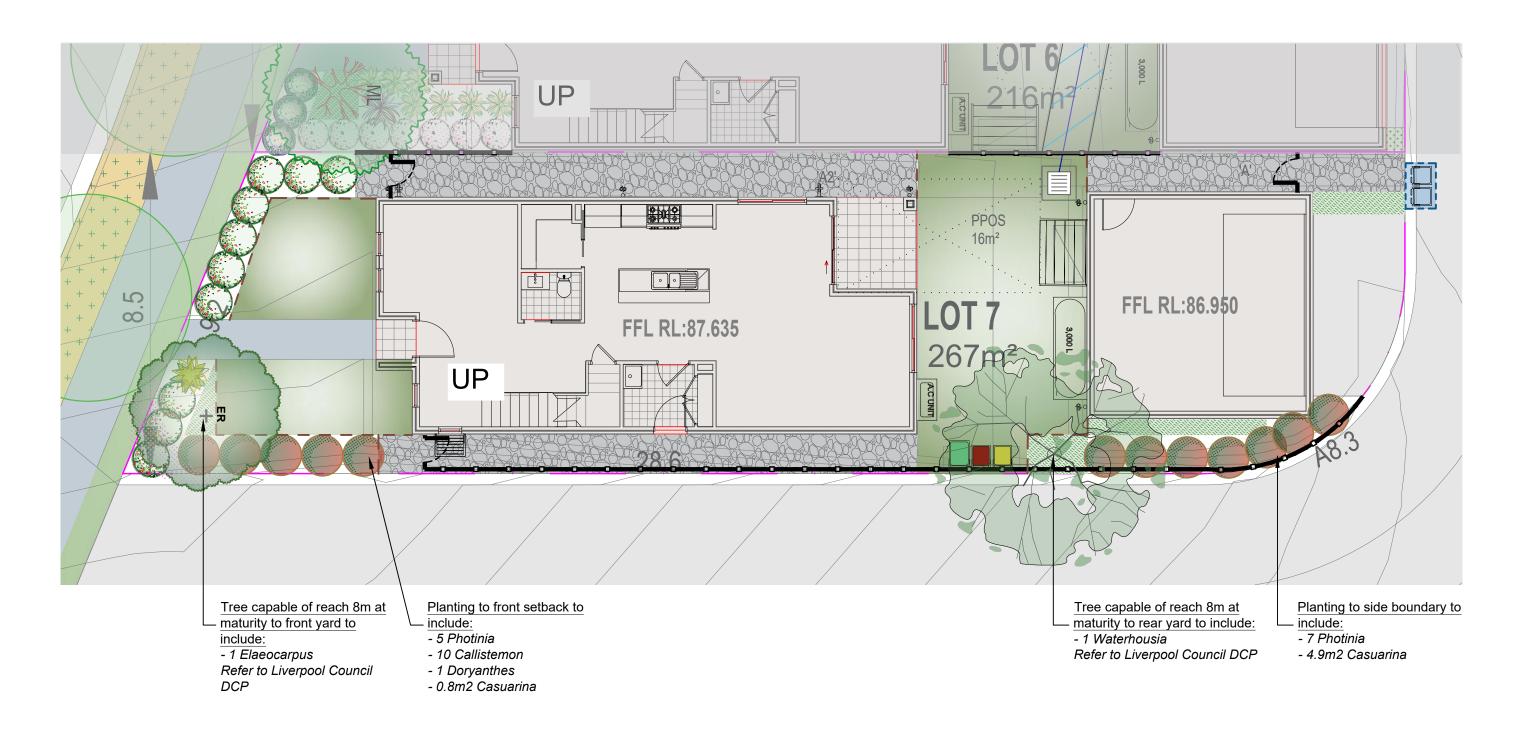
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construction purposes. Enterprises (T/A Conzent) until such time as all ar following th



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6

Botanical Name: Elaeocarpus reticulatus **Common Name:** Blueberry Ash (Native) 75Lt 8-10m x 6-7m

Botanical Name: Waterhousia floribunda Common Name: Weeping Lilly Pilly (Native)

1:100 @ A3

5

SHRUBS AND HEDGES Botanical Name: Callistemon 'Better John'

REV DATE NOTATION/AMENDMENT

B 20.09.2023 Coordinated with site plan updates

C 25.10.2023 Coordinated with site plan updates

D 01.11.2023 Coordinated with site plan updates

A 31.03.2023 For submission

Pot size: Mature H x S: Qty Required: Pot size: Mature H x S: Qty Required:

Common Name: Better John Bottlebrush (Native) 200mm 1m x 0.9m 10 Botanical Name: Photinia 'Red Robin' Common Name: Red Robin Photinia (Exotic) 200mm

1.5-3m x 1.5-2.5m 12

FEATURE PLANTS


Botanical Name: Doryanthes excelsa Pot size: Qty Required:

Common Name: Gymea Lily (Native) 300mm Mature H x S: 1.1m x 1m 1 **GROUNDCOVER & GRASSES** Botanical Name: Casuarina glauca 'Cousin It'

Pot size: Mature H x S: Qty Required:

Common Name: Cousin It Casuarina (Native) 140mm 0.1m x 1.5m 5/m2 (5.7 m2 total)

	- 44	Suit 101, 506 Miller Street, CAMMERAY NSW 2062
CLIENT NEW LIVING HOMES	ie	Phone: 9922 5312
STATUS / ISSUE	E	Fax: 8209 4982 Mob: 0413 861 351
DA - ISSUE D	conzept	www.conzept.net.a
1	Landscape Architects	enquiries@conzept

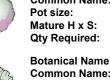

Pot size: 75Lt Mature H x S: 10m x 6m Qty Required: 1

SCALE:


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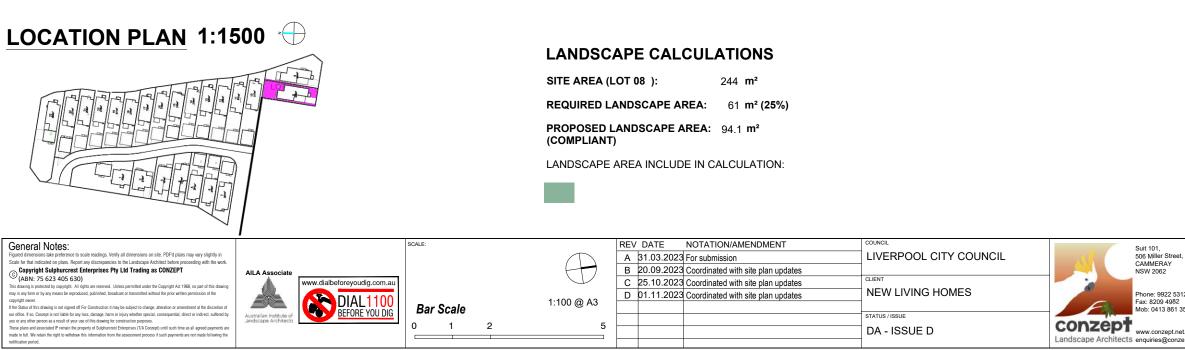
Bar Scale

1


2

	TITLE:	DWG.No:		
eet,	LANDSCAPE PLAN	LPDA 23-235 / 14		
	(LOT 07)	DATE:		
5312 32 1 351	PROPOSED RESIDENTIAL SUBDIVISION	NOV 2023		
	280 FIFTH AVE (LOT 07)	DRAWN:	CHECKED:	
.net.au nzept.net.au	AUSTRAL	C.D/L.Z	R.F	



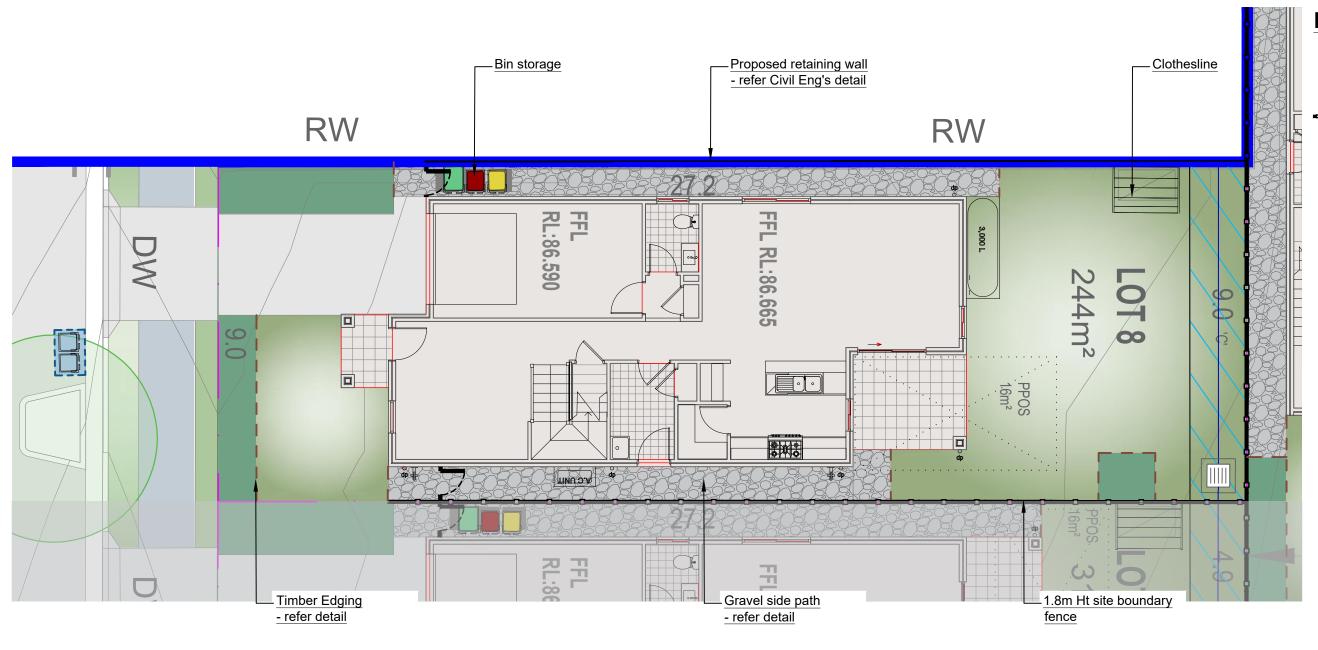

LANDSCAPE ITEMS

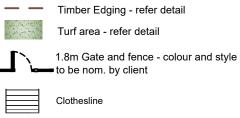

Timber Edging - refer detail Turf area - refer detail

Clothesline

Decorative gravel mulch



Bin collection area



Bin storage area

	TITLE:	DWG.No:	
reet,	HARDSCAPE PLAN	LPDA 23	-235 / 15
	(LOT 08)	DATE:	
5312 982 61 351	PROPOSED RESIDENTIAL SUBDIVISION	NOV	2023
	280 FIFTH AVE	DRAWN:	CHECKED:
t.net.au onzept.net.au	AUSTRAL	C.D/L.Z	R.F

NOTES

1. ALL FINAL PLANT QUANTITIES INDICATED ON PLANS SHALL BE CHECKED AND VERIFIED BY SUCCESSFUL LANDSCAPE CONTRACTOR.

VERIFIED BY SUCCESSFUL EXAUSOLARE DURING TO THE ADVITAGE TO A SUBSTITUTES REQUIRED DUE TO UNAVAILABILITY SHALL BE RECOMMENDED BY THE LANDSCAPE CONTRACTOR TO BEST MATCH SUBSTITUTED PLANTS AND APPROVED PRIOR TO PURCHASING BY THE LANDSCAPE ARCHITECT. 2. WORKS CERTIFIED FOR FINAL OCCUPANCY CERTIFICATE ARE TO MATCH APPROVED LANDSCAPE PLANS.

4 - LANDSCHEP CONTRACTOR SHALL LOCATE AND AVOID SITE STORM WATER & DRAINAGE SERVICES. LOCATE TREES A MINIMUM 1.25M FROM PITS 5. ALL PLANTING AROUND EXISTING TREES SHALL BE ADJUSTED TO AVOID DAMAGE

AND CLASHING WITH SURFACE ROOTS. 6. THE NATURE STRIP (STREET FRONTAGE) FOR THE SITE IS PUBLIC LAND, AND ONLY AUTHORIZED WORKS MAY OCCUR HERE. EXISTING CONDITIONS SUCH AS

STREET TREES, COUNCID PLANTING ETC SHALL BE RETAINED AND PROTECTED DURING CONSTRUCTION, UNLESS SPECIFIC APPROVAL HAS BEEN GRANTED FOR NEW WORK IN THIS AREA.

7. ALL TREES TO BE SOURCED IN ACCORDANCE WITH TESTS AND MEASUREMENTS CONTAINED WITHIN AS 2303-2015 - TREE STOCK FOR LANDSCAPE USE

TREES

er + Pot size:

Botanical Name: Elaeocarpus reticulatus Common Name: Blueberry Ash (Native) 75Lt 8-10m x 6-7m Mature H x S: Qty Required: 1

Botanical Name: Waterhousia floribunda Common Name: Weeping Lilly Pilly (Native) Pot size: 75Lt Mature H x S: 10m x 6m Qty Required: 1

SHRUBS AND HEDGES

Pot size:

Botanical Name: Callistemon 'Better John' Common Name: Better John Bottlebrush (Native) 200mm 1m x 0.9m Mature H x S: Qty Required: 8


FEATURE PLANTS




Botanical Name: Phormium tenax 'Purpureum' Common Name: New Zealand Flax (Exotic) Pot size: 300mm Mature H x S: 0.9m x 0.9m Qty Required: 1


GROUNDCOVER & GRASSES

Botanical Name: Myoporum parvifolium 'Yareena' **Common Name:** Creeping Boobialla (Native) Pot size: 140mm Mature H x S: 0.15m x spreading Qty Required: 7/m2 (3.3m2 total)

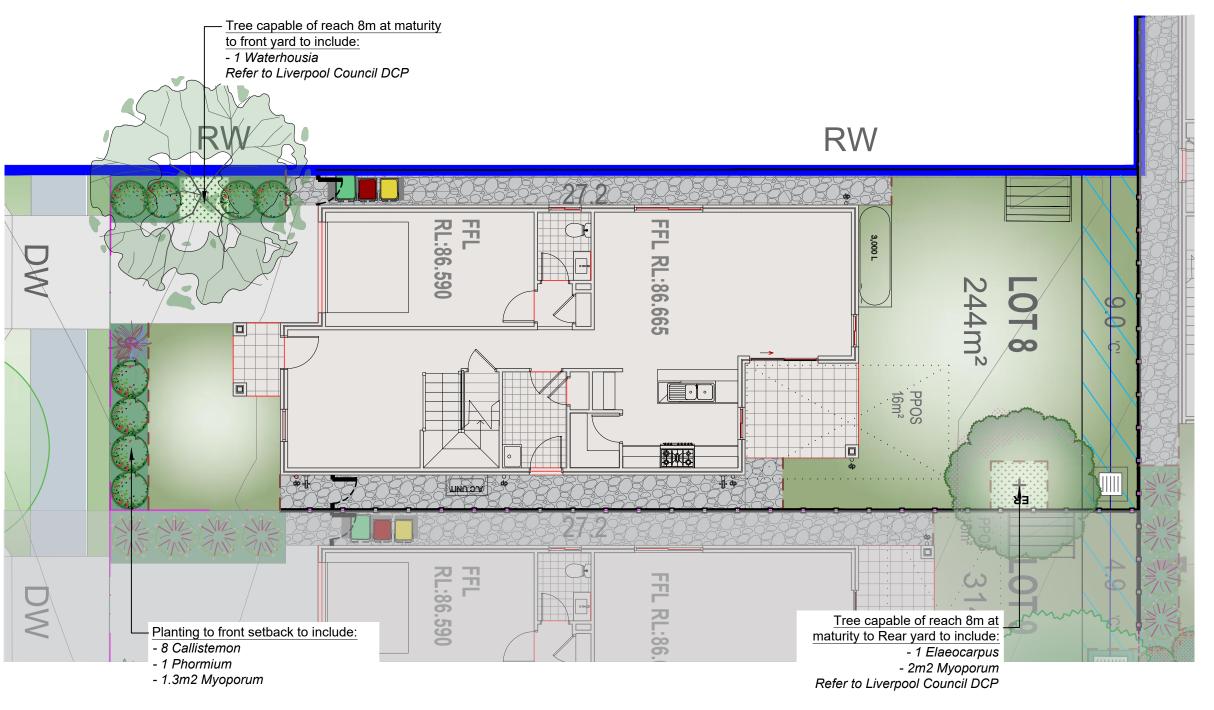


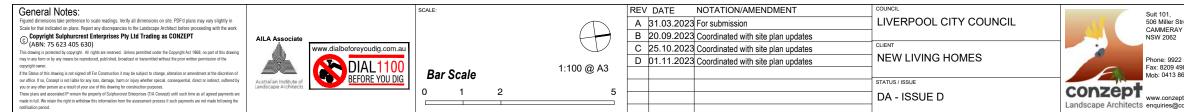

	TITLE:	DWG.No:		
reet,	LANDSCAPE PLAN	LPDA 23-235 / 16		
	(LOT 08)	DATE:		
5312 82 51 351	PROPOSED RESIDENTIAL SUBDIVISION	NOV 2023		
	280 FIFTH AVE	DRAWN:	CHECKED:	
t.net.au onzept.net.au	AUSTRAL	C.D/L.Z	R.F	

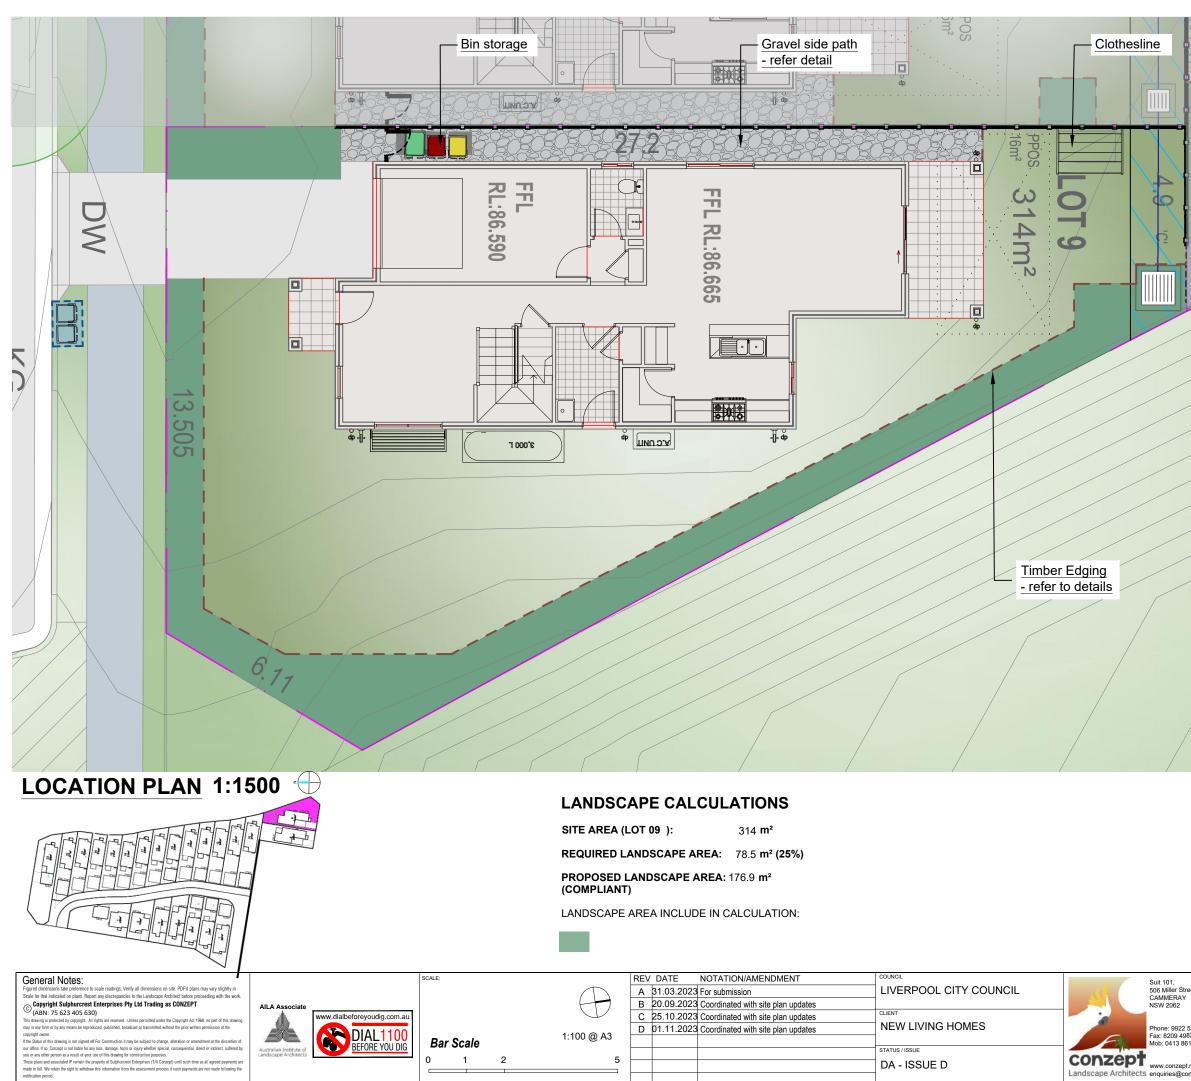

LANDSCAPE ITEMS

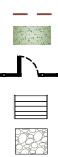

- Timber Edging - refer detail

Turf area - refer detail

1.8m Gate and fence - colour and style to be nom. by client



Decorative gravel mulch

Clothesline



Bin collection area



	TITLE:	DWG.No:	
reet,	HARDSCAPE PLAN	LPDA 23	-235 / 17
	(LOT 09)	DATE:	
5312 82 51 351	PROPOSED RESIDENTIAL SUBDIVISION	NOV	2023
	280 FIFTH AVE	DRAWN:	CHECKED:
t.net.au onzept.net.au	AUSTRAL	C.D/L.Z	R.F

NOTES:

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7. ALL TREES TO BE SOURCED IN ACCORDANCE WITH TESTS AND MEASUREMENTS CONTAINED WITHIN AS 2303-2015 - TREE STOCK FOR LANDSCAPE USE

TREES

Botanical Name: Melaleuca linarifolia **Common Name:** Snow in Summer (Native) Pot size: 75Lt Mature H x S: 8m x 4-6m Qty Required: 1

SHRUBS AND HEDGES




Botanical Name: Westringia 'Aussie Box' **Common Name:** Westringia Aussie Box (Native) 200mm Mature H x S: 0.9m x 0.9m Qty Required: 9

Pot size: Mature H x S: Qty Required:

Botanical Name: Photinia 'Red Robin' Common Name: Red Robin Photinia (Exotic) 200mm 1.5-3m x 1.5-2.5m 23

Botanical Name: Callistemon citrinus 'White Anzac' Common Name: Callistemon White Anzac (Native) Pot size: 300mm 1.4m x 2m Mature H x S: Qty Required: 4

FEATURE PLANTS

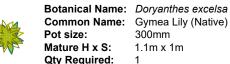


Common Name: Gymea Lily (Native) 300mm Pot size: Mature H x S: 1.1m x 1m Qty Required: 1

GROUNDCOVER & GRASSES




Botanical Name: Myoporum parvifolium 'Yareena' **Common Name:** Creeping Boobialla (Native) Pot size: 140mm Mature H x S: 0.15m x spreading 7/m2 (3m2 total) Qty Required:

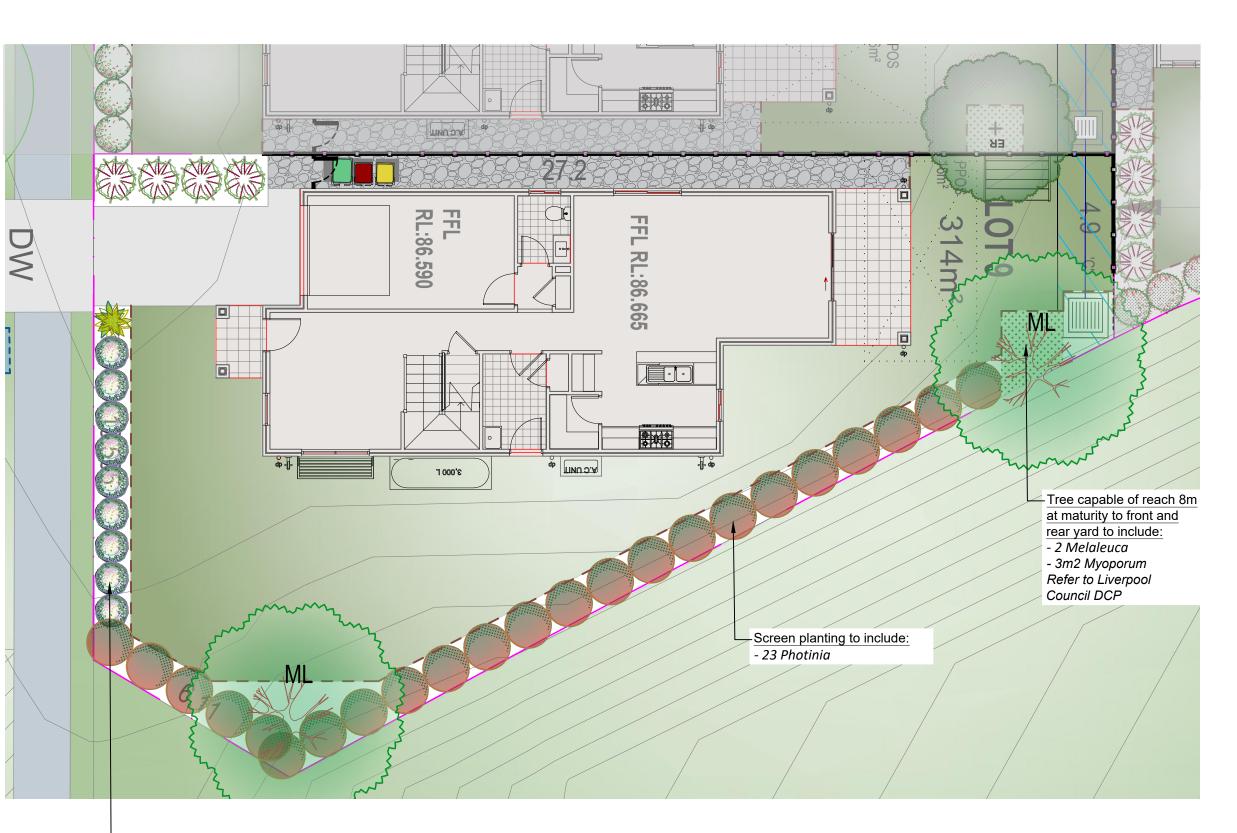


-Planting to front to include:


- 9 Westringia
- 1 Doryanthes
- 4 Callistemon

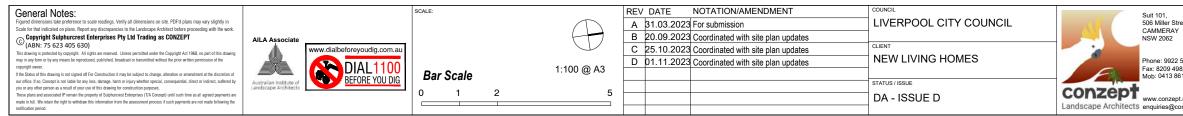

	TITLE:	DWG.No:		
eet,	LANDSCAPE PLAN	LPDA 23-235 / 18		
	(LOT 09)	DATE:		
5312 12 1 351	PROPOSED RESIDENTIAL SUBDIVISION	NOV 2023		
	280 FIFTH AVE	DRAWN:	CHECKED:	
.net.au nzept.net.au	AUSTRAL	C.D/L.Z	R.F	

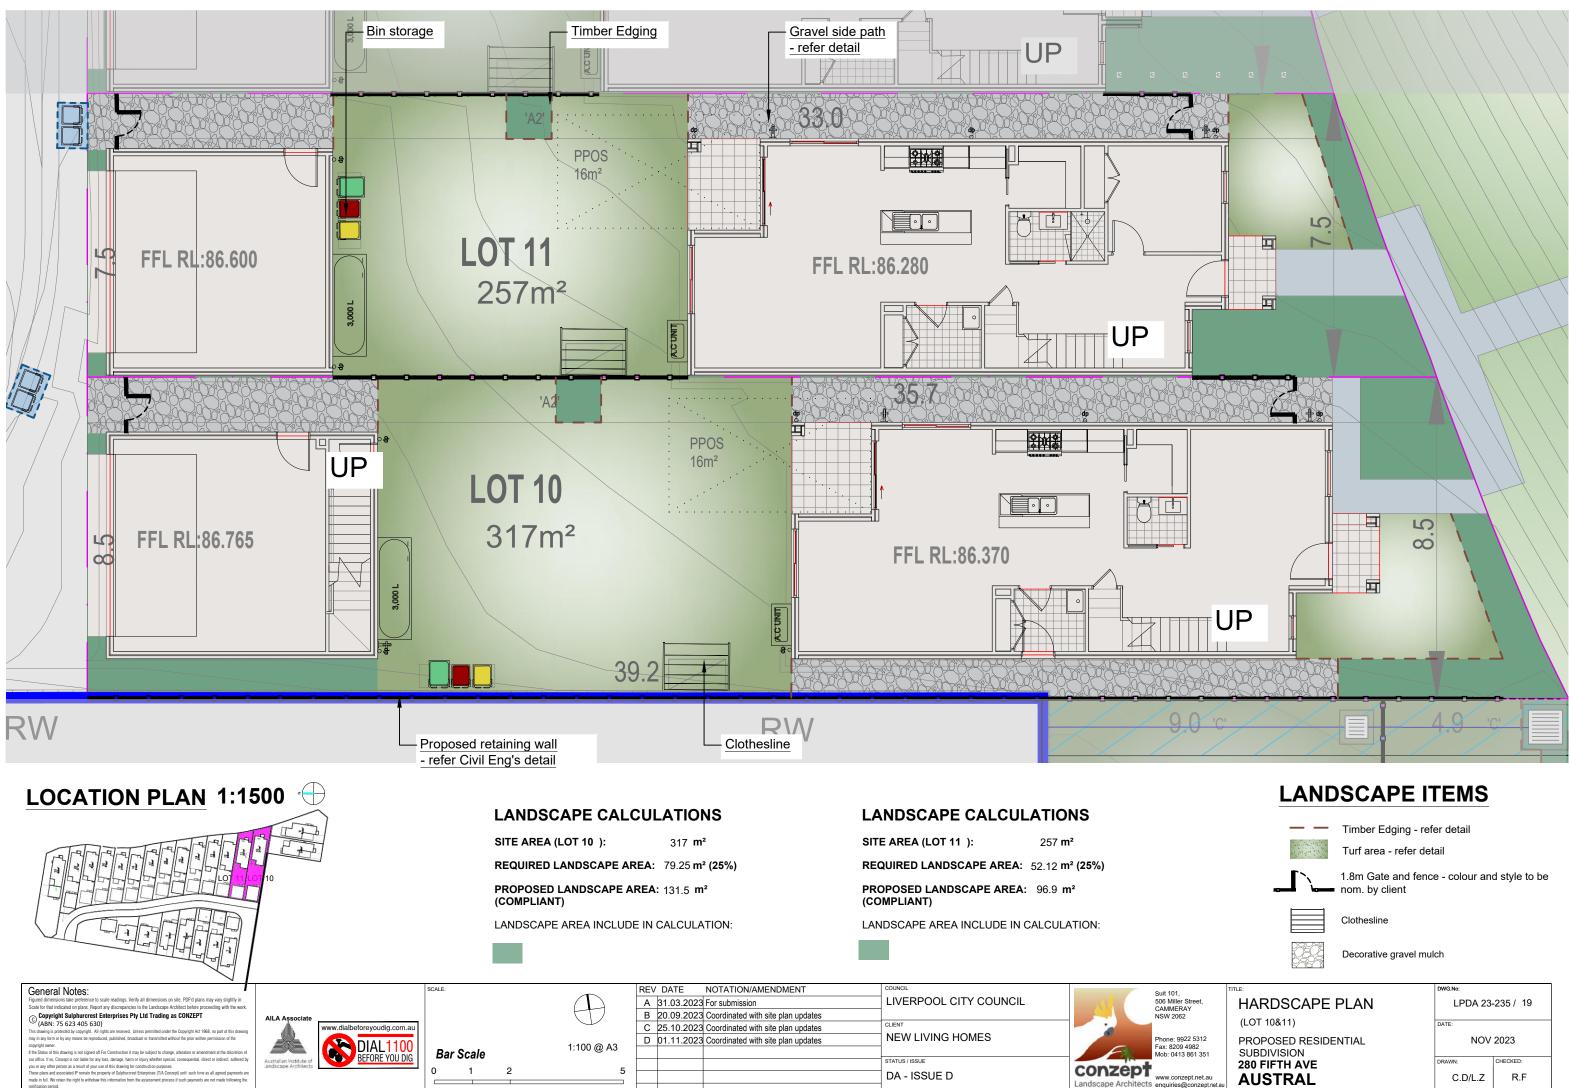

	TITLE:	DWG.No:		
eet,	HARDSCAPE PLAN	LPDA 23-235 / 19		
	(LOT 10&11)	DATE:		
5312 82 61 351	PROPOSED RESIDENTIAL SUBDIVISION	NOV	2023	
	280 FIFTH AVE	DRAWN:	CHECKED:	
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STATUS / ISSI
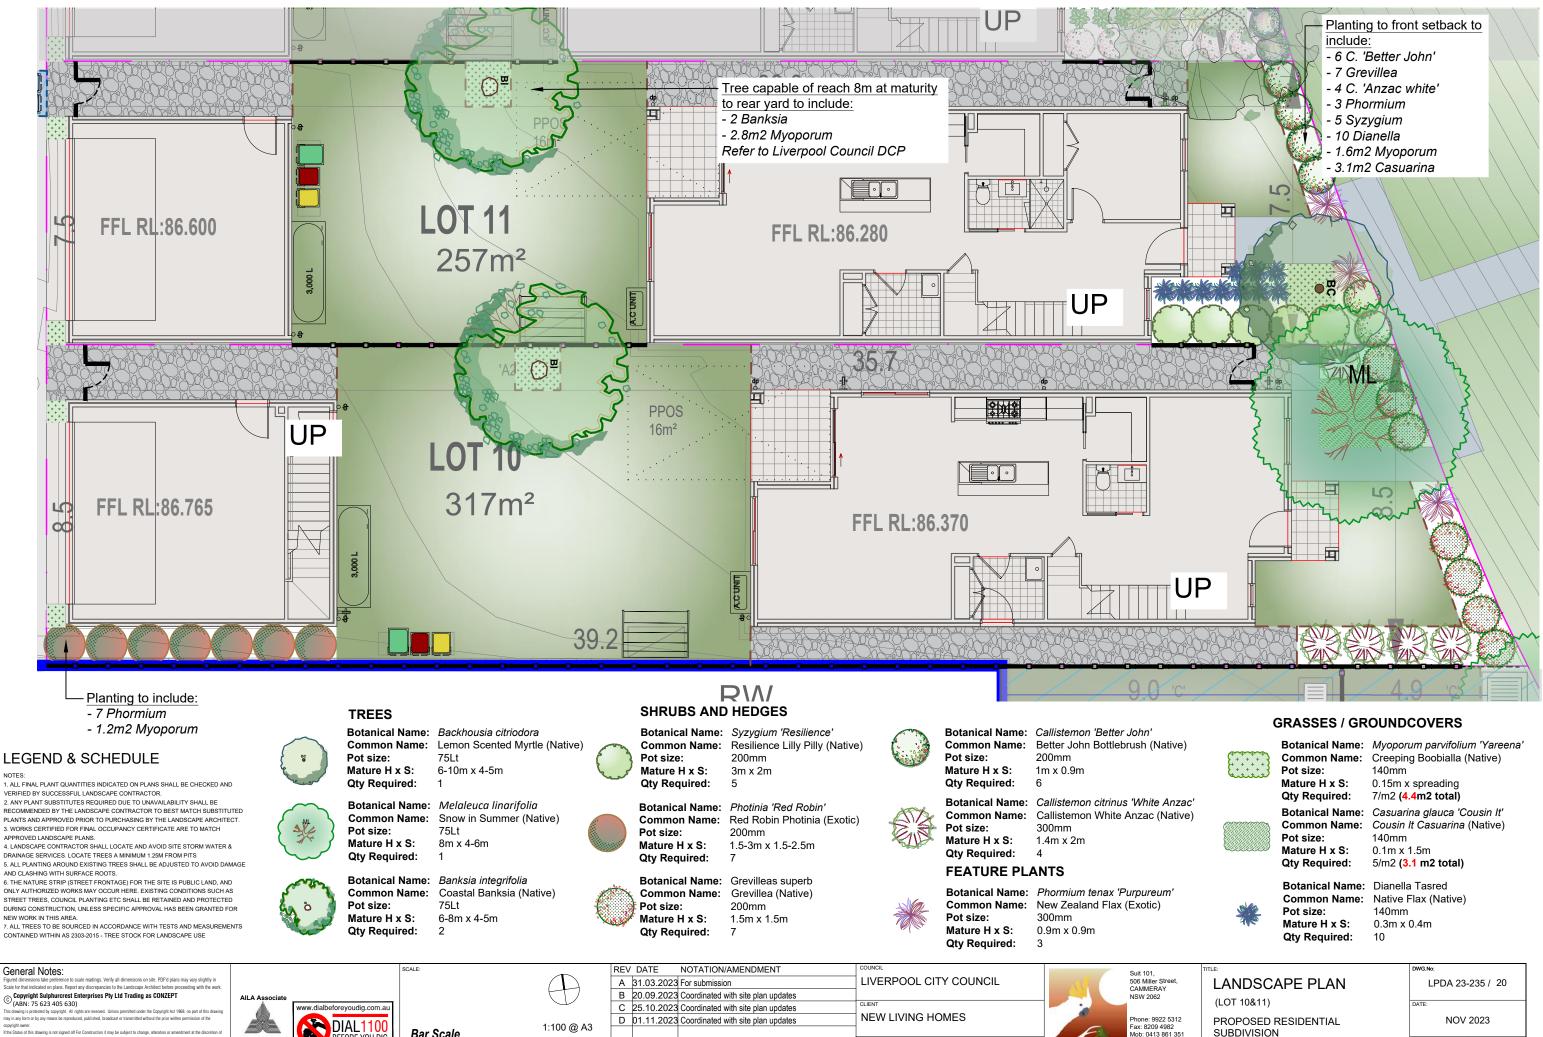
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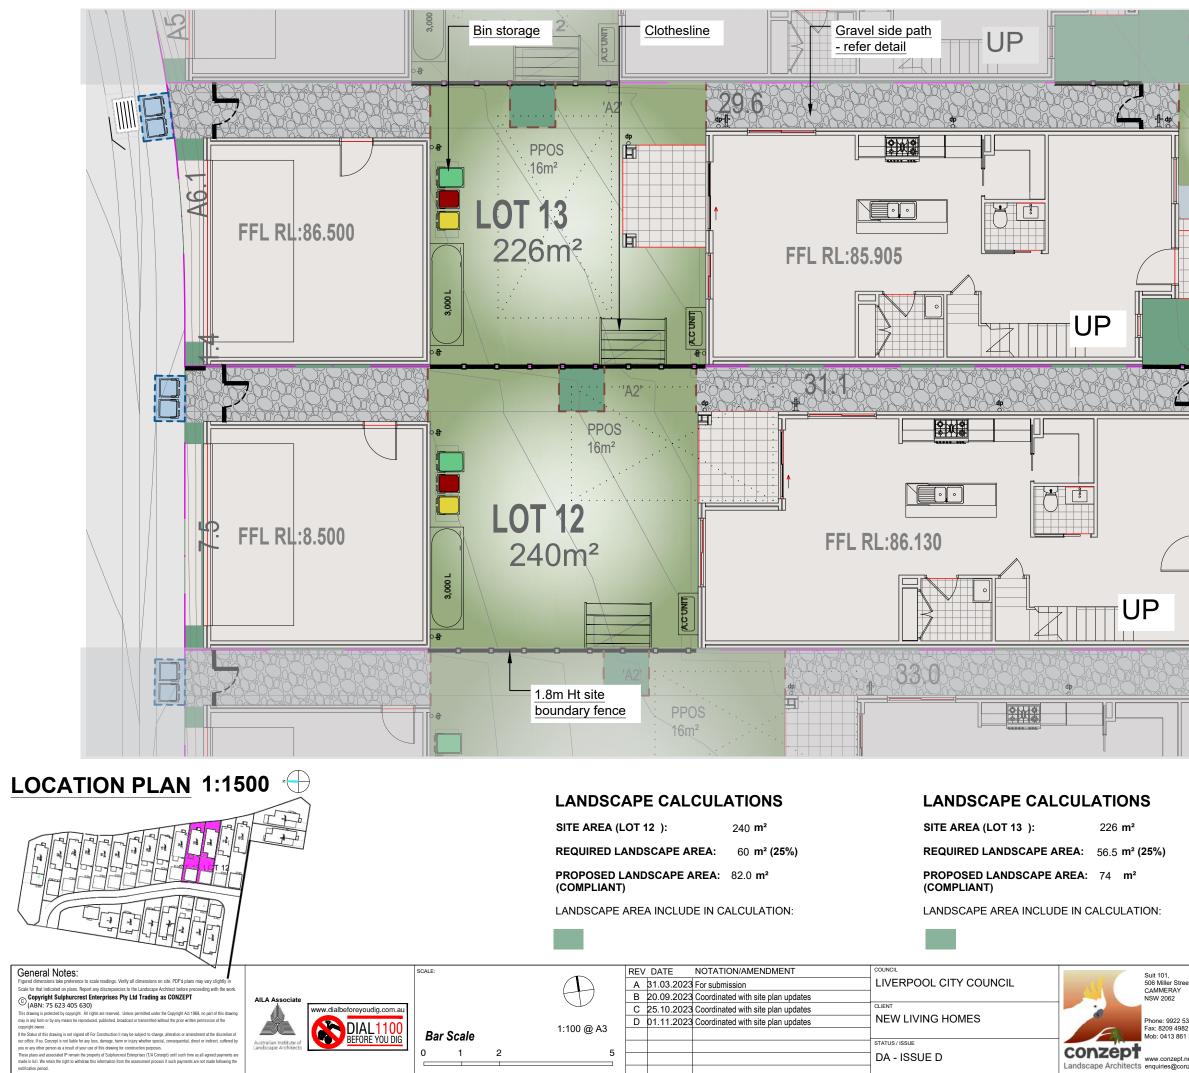


Bar Scale 1 2 0

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conzept www.conzept.net.au Landscape Architects enquiries@conzent.net.a SUBDIVISION 280 FIFTH AVE AUSTRAL

C.D/L.Z R.F



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LANDSCAPE ITEMS

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Timber Edging - refer detail



Turf area - refer detail




1.8m Gate and fence - colour and style to be nom. by client




Clothesline

Decorative gravel mulch

	TITLE:	DWG.No:		
et,	HARDSCAPE PLAN	LPDA 23-235 / 21		
	(LOT 12&13)	DATE:		
5312 12 1 351	PROPOSED RESIDENTIAL SUBDIVISION	NOV 2023		
	280 FIFTH AVE	DRAWN:	CHECKED:	
net.au nzept.net.au	AUSTRAL	C.D/L.Z	R.F	

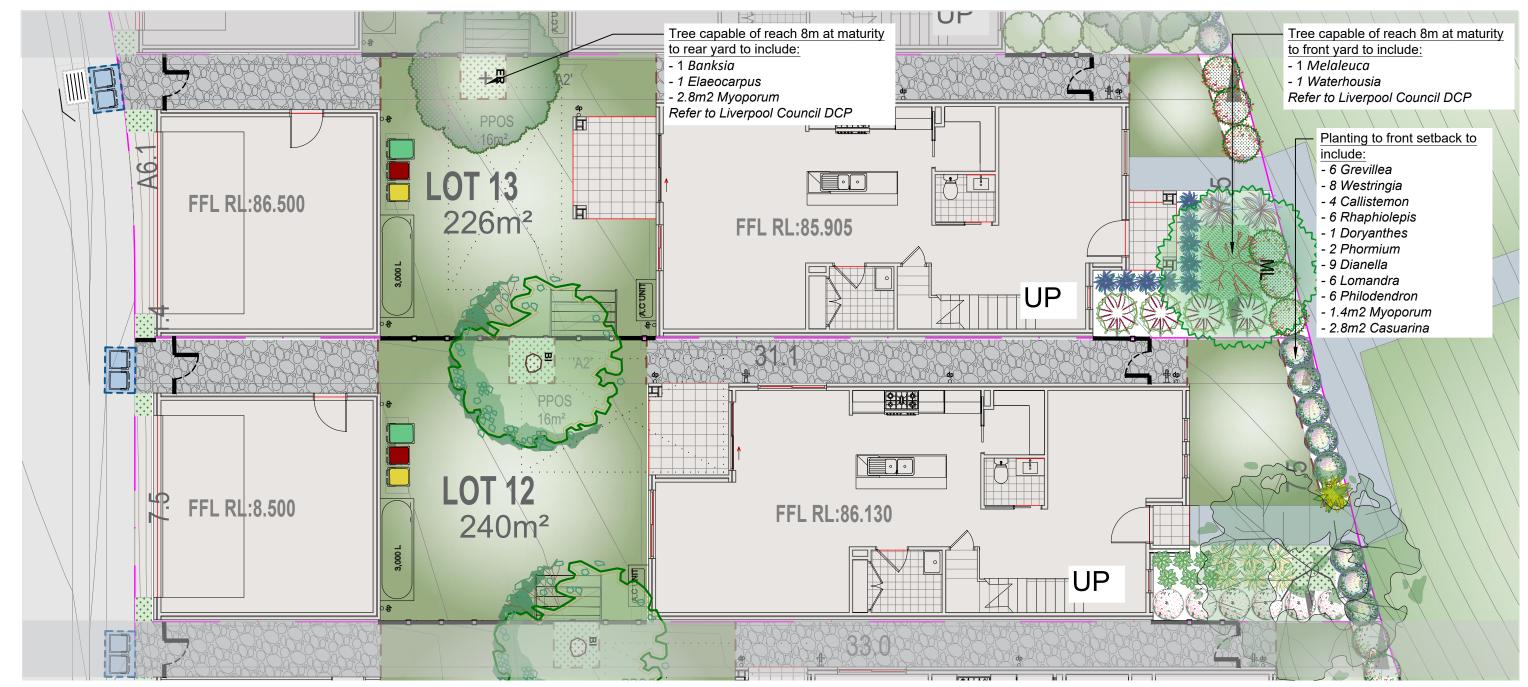

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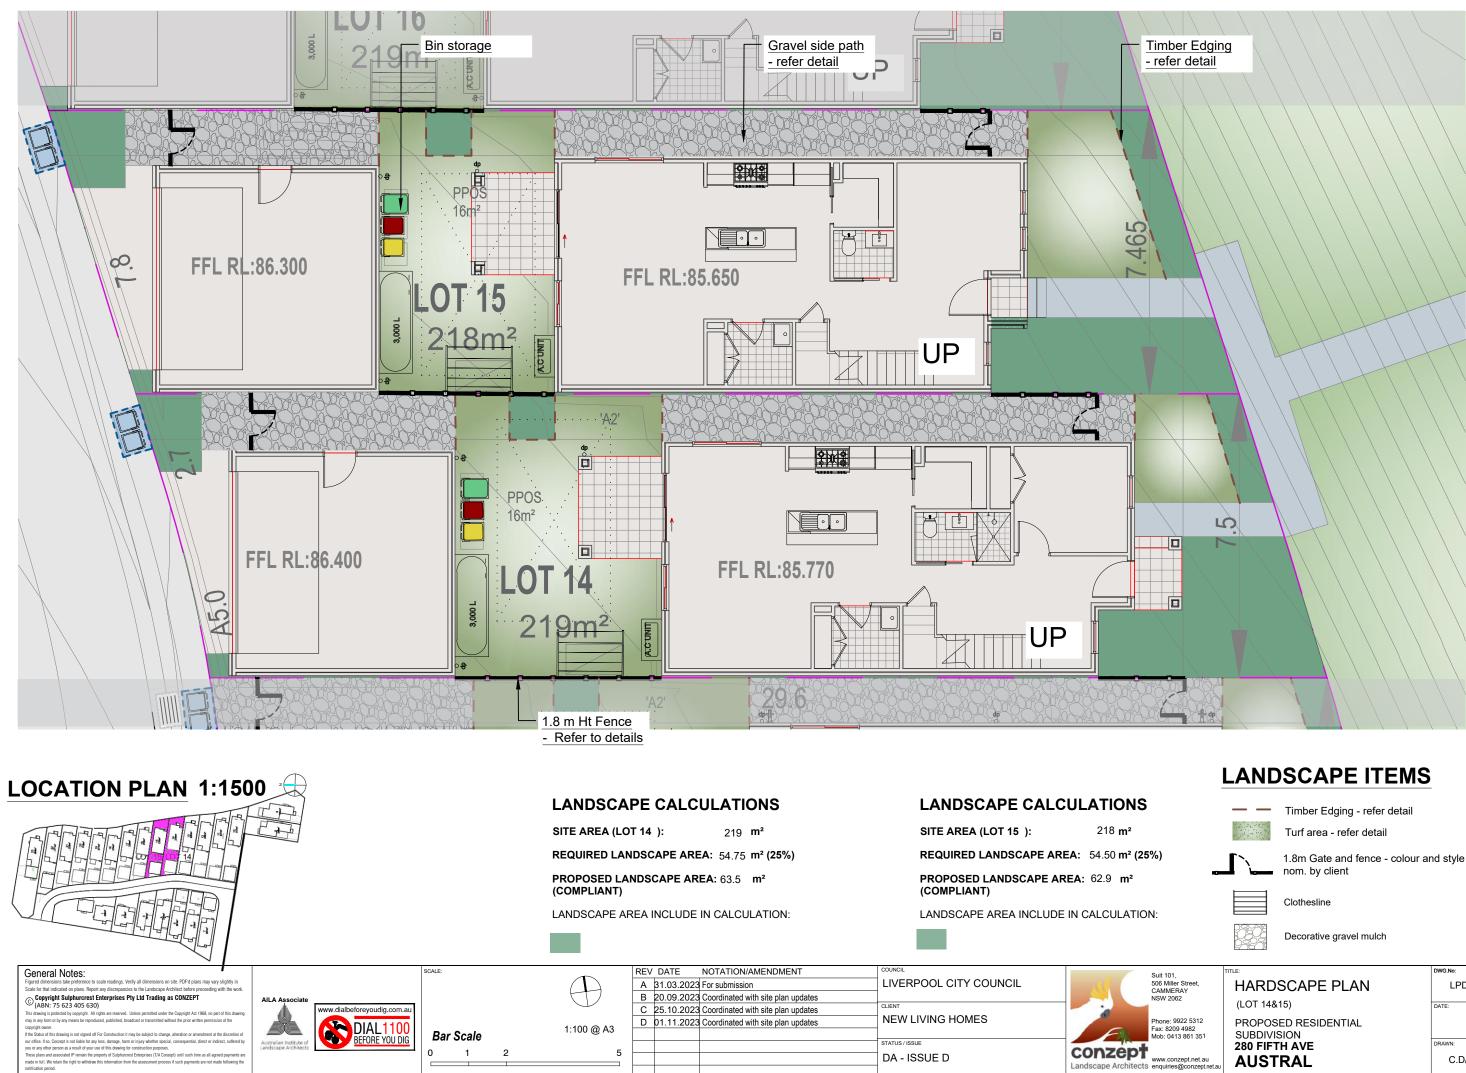
Pot size: Mature H x S: Qty Required:

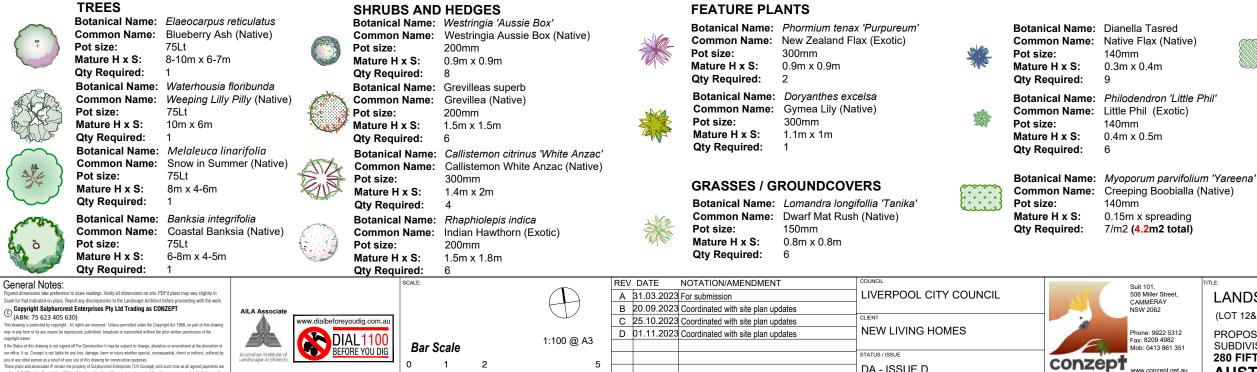Botanical Name: Casuarina glauca 'Cousin It' Common Name: Cousin It Casuarina (Native) 140mm 0.1m x 1.5m 5/m2 (2.8 m2 total)

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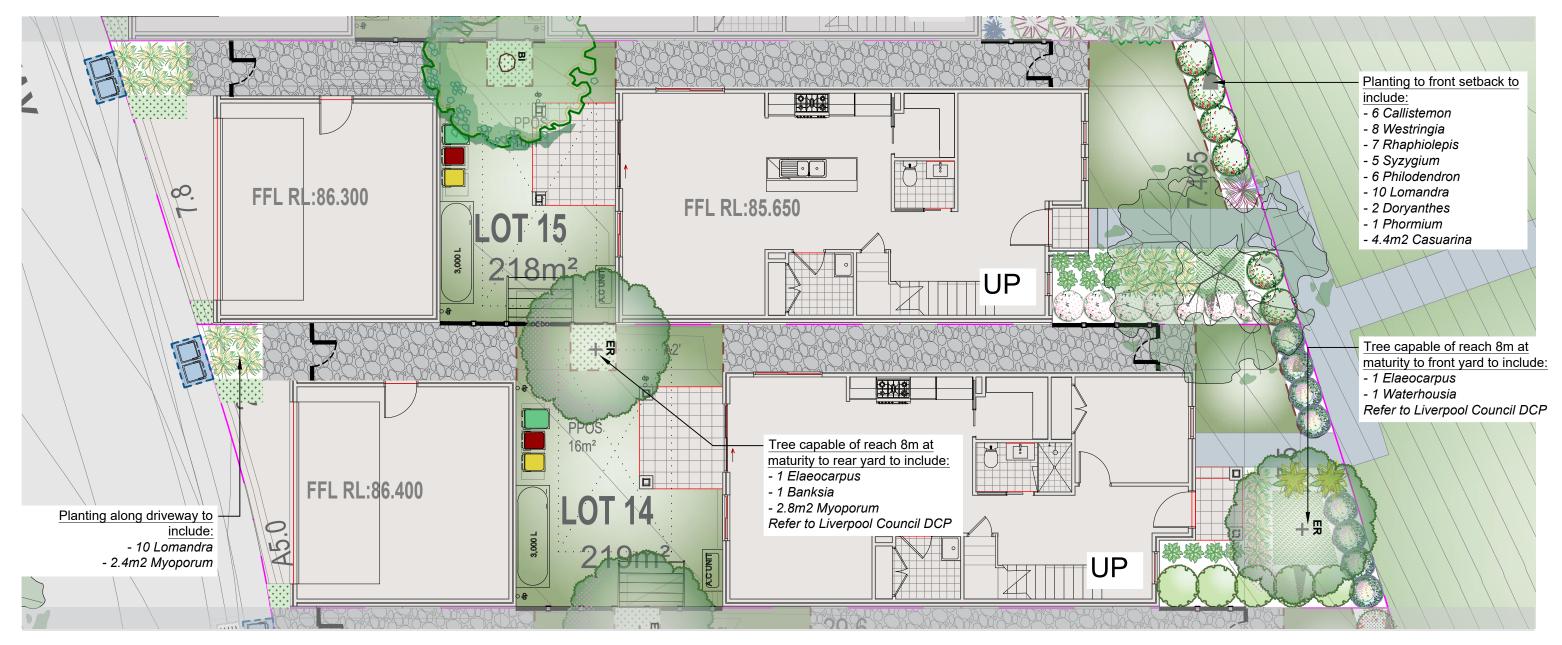
Landscape Architects enquiries@c

	TITLE:	DWG.No:	
et,	LANDSCAPE PLAN	LPDA 23-	-235 / 22
	(LOT 12&13)	DATE:	
312 2 1 351	PROPOSED RESIDENTIAL SUBDIVISION	NOV	2023
	280 FIFTH AVE (LOT 12-13)	DRAWN:	CHECKED:
net.au nzept.net.au	AUSTRAL	C.D/L.Z	R.F



1.8m Gate and fence - colour and style to be

	TITLE:	DWG.No:		
eet,	HARDSCAPE PLAN	LPDA 23-235 / 23		
	(LOT 14&15)	DATE:		
5312 32 1.351	PROPOSED RESIDENTIAL SUBDIVISION	NOV	2023	
	280 FIFTH AVE	DRAWN:	CHECKED:	
.net.au nzept.net.au	AUSTRAL	C.D/L.Z	R.F	



NOTES:

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5. ALL PLANTING AROUND EXISTING TREES SHALL BE ADJUSTED TO AVOID DAMAGE AND CLASHING WITH SURFACE ROOTS.

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7. ALL TREES TO BE SOURCED IN ACCORDANCE WITH TESTS AND MEASUREMENTS CONTAINED WITHIN AS 2303-2015 - TREE STOCK FOR LANDSCAPE USE



Pot size:

Pot size:

Pot size:

Botanical Name: *Elaeocarpus reticulatus*

Ö

Common Name: Blueberry Ash (Native) 75Lt Mature H x S: 8-10m x 6-7m Qty Required: 2

Botanical Name: Banksia integrifolia **Common Name:** Coastal Banksia (Native) 75I t Mature H x S: 6-8m x 4-5m

Qty Required: 1

Botanical Name: Waterhousia floribunda **Common Name:** Weeping Lilly Pilly (Native) 75Lt Mature H x S: 10m x 6m Qty Required: 1



Botanical Name: Rhaphiolepis indica Pot size:

Pot size:

Mature H x S:

Qty Required:

Pot size: Mature H x S: Qty Required: 8

Botanical Name: Callistemon 'Better John' Common Name: Better John Bottlebrush (Native) Pot size: 200mm Mature H x S: 1m x 0.9m Qty Required: 6

FEATURE PLANTS

Qty Required:

	· · · · · · · · · · · · · · · · · · ·
Common Name:	New Zealand Flax (Exotic)
Pot size:	300mm
Mature H x S:	0.9m x 0.9m
Qty Required:	1
Botanical Name:	Doryanthes excelsa
Common Name:	Gymea Lily (Native)
Pot size:	300mm
Mature H x S:	1.1m x 1m
Qty Required:	2
aty nequired.	2
GRASSES / G	ROUNDCOVERS
Botanical Name:	Lomandra longifollia 'Tanika'
Common Name:	Dwarf Mat Rush (Native)
Pot size:	150mm
Mature H x S:	0.8m x 0.8m
Qty Required:	20
Botanical Name:	Philodendron 'Little Phil'
Common Name:	Little Phil (Exotic)
Pot size:	140mm
Mature H x S:	0.4m x 0.5m

0.4m x 0.5m 6

General Notes:			SCALE:		~	REV	DATE	NOTATION/AMENDMENT	COUNCIL		Suit 101,
Figured dimensions take preference to scale readings. Verify all dimensions on site. PDFd plans may vary slightly in Scale for that indicated on plans. Report any discrepancies to the Landscape Architect before proceeding with the work.						Α	31.03.2023	For submission	LIVERPOOL CITY COUNCIL	and the second second	506 Miller Street, CAMMERAY
Copyright Sulphurcrest Enterprises Pty Ltd Trading as CONZEPT	AILA Associate				\square	В	20.09.2023	Coordinated with site plan updates			NSW 2062
(ABN: 75 623 405 630) This drawing is protected by copyright. All rights are reserved. Unless permitted under the Copyright Act 1968, no part of this drawing	www.dialb	peforeyoudig.com.au			<u> </u>	С	25.10.2023	Coordinated with site plan updates	CLIENT		1
may in any form or by any means be reproduced, published, broadcast or transmitted without the prior written permission of the copyright owner.		DIAL1100			1:100 @ A3	D	01.11.2023	Coordinated with site plan updates	NEW LIVING HOMES		Phone: 9922 5312 Fax: 8209 4982
If the Status of this drawing is not signed off For Construction it may be subject to change, alteration or amendment at the discretion of our office. If so, Concept is not liable for any loss, damage, harm or injury whether special, consequential, direct or indirect, suffered by		BEFORE YOU DIG	Bar Scale		1.100 @ AS						Mob: 0413 861 35
you or any other person as a result of your use of this drawing for construction purposes.	Australian Institute of Landscape Architects	DEFORE TOO DIG	0 1	2	5				STATUS / ISSUE	conzep'	Ē
These plans and associated IP remain the property of Sulphurcrest Enterprises (T/A Concept) until such time as all agreed payments are made in full. We retain the right to withdraw this information from the assessment process if such payments are not made following the				2					DA - ISSUE D	Landscape Architec	www.conzept.net.
notification period.										Lanuscape Architec	a enquines@conzepi



SHRUBS AND HEDGES

Botanical Name: Syzygium 'Resilience'

5

Common Name: Resilience Lilly Pilly (Native)

200mm

3m x 2m

Botanical Name: Phormium tenax 'Purpureum'





Pot size: Mature H x S: Qty Required: Pot size: Mature H x S: Qty Required:

Botanical Name: Myoporum parvifolium 'Yareena' **Common Name:** Creeping Boobialla (Native) 140mm 0.15m x spreading 7/m2 (5.2m2 total) Botanical Name: Casuarina glauca 'Cousin It'

Common Name: Cousin It Casuarina (Native) 140mm 0.1m x 1.5m 5/m2 (4.4 m2 total)

)1.	TITLE:	DWG.No:		
iller Street, IERAY	LANDSCAPE PLAN	LPDA 23-235 / 24		
2062	(LOT 14&15)	DATE:		
: 9922 5312 209 4982 1413 861 351	PROPOSED RESIDENTIAL SUBDIVISION	NOV 2023		
	280 FIFTH AVE (LOT 14-15)	DRAWN:	CHECKED:	
conzept.net.au ies@conzept.net.au	AUSTRAL	C.D/L.Z	R.F	

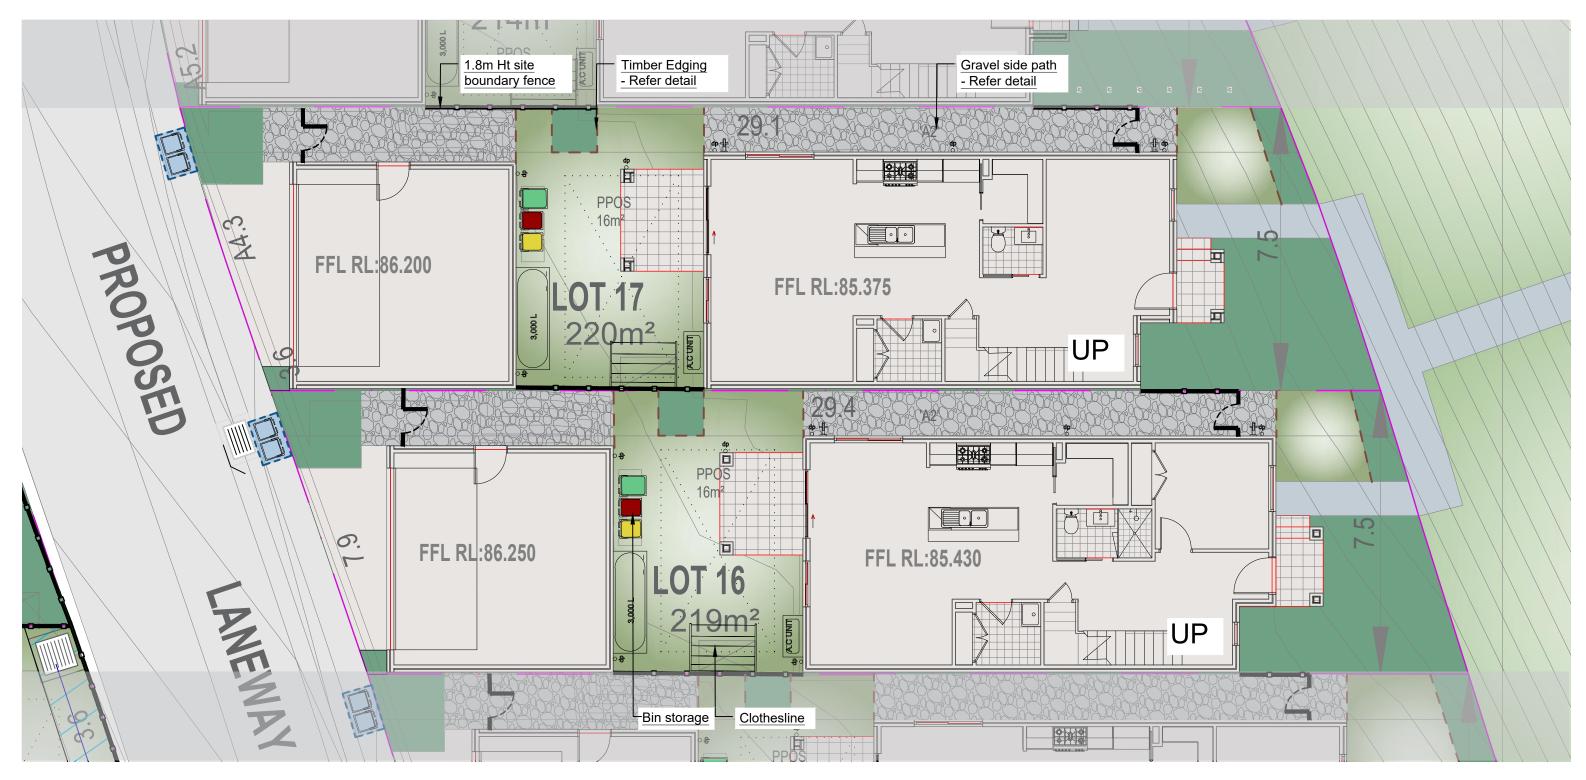

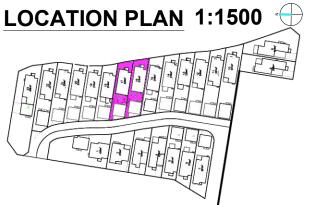

LANDSCAPE CALCULATIONS

SITE AREA (LOT 16): 219 m²

REQUIRED LANDSCAPE AREA: 54.75 m² (25%)

PROPOSED LANDSCAPE AREA: 60.9 m² (COMPLIANT)

LANDSCAPE AREA INCLUDE IN CALCULATION:


LANDSCAPE CALCULATIONS

SITE AREA (LOT 17): 220 m²

REQUIRED LANDSCAPE AREA: 55 m² (25%)

PROPOSED LANDSCAPE AREA: 61.9 m² (COMPLIANT)

LANDSCAPE AREA INCLUDE IN CALCULATION:

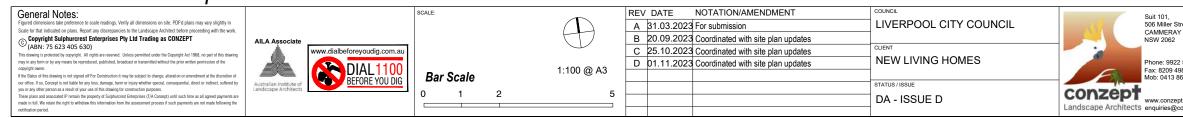

LANDSCAPE ITEMS

Timber Edging - refer detail



Turf area - refer detail



1.8m Gate and fence - colour and style to be nom. by client




Clothesline



Decorative gravel mulch

	TITLE:	DWG.No:		
r Street, RAY	HARDSCAPE PLAN	LPDA 23-235 / 25		
2	(LOT 16&17)	DATE:		
922 5312 9 4982 3 861 351	PROPOSED RESIDENTIAL SUBDIVISION	NOV	2023	
	280 FIFTH AVE	DRAWN:	CHECKED:	1
zept.net.au @conzept.net.au	AUSTRAL	C.D/L.Z	R.F	

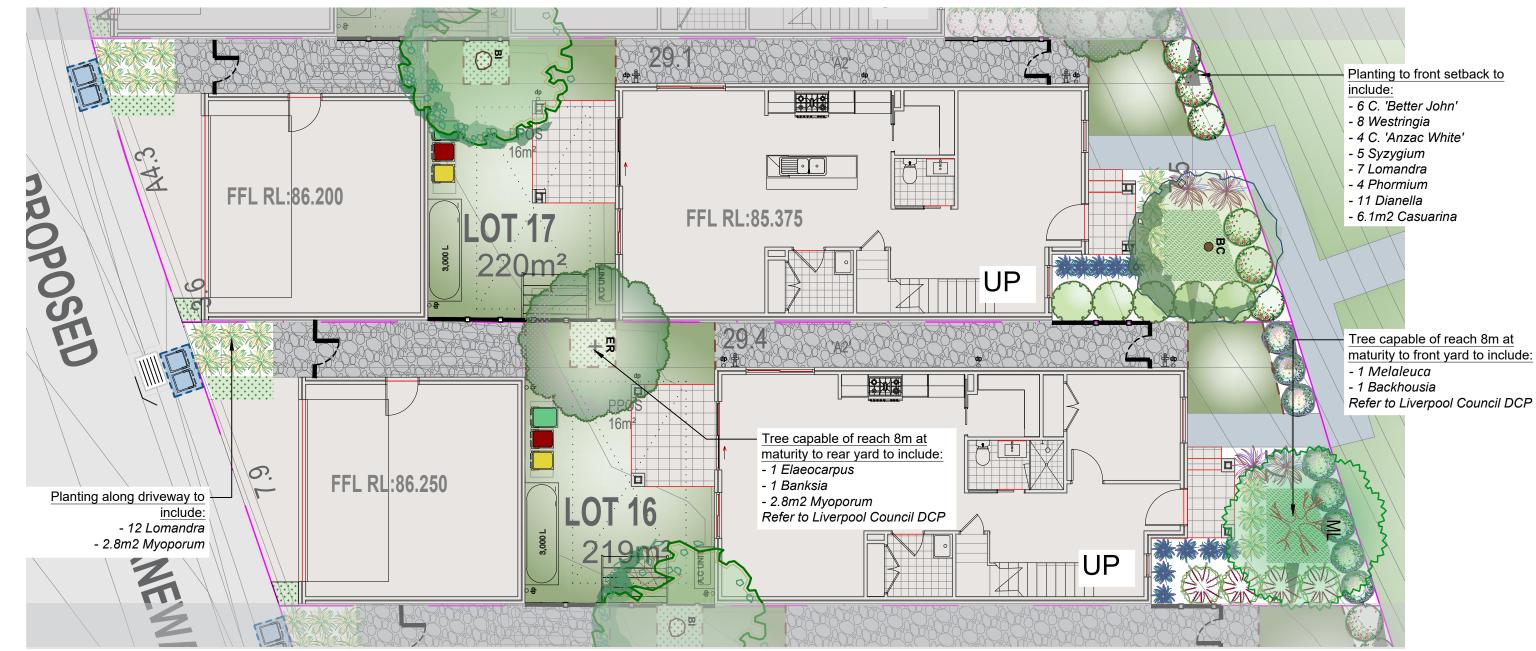

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5. ALL PLANTING AROUND EXISTING TREES SHALL BE ADJUSTED TO AVOID DAMAGE AND CLASHING WITH SURFACE ROOTS.

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7. ALL TREES TO BE SOURCED IN ACCORDANCE WITH TESTS AND MEASUREMENTS CONTAINED WITHIN AS 2303-2015 - TREE STOCK FOR LANDSCAPE USE





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BC

Botanical Name: Elaeocarpus reticulatus **Common Name:** Blueberry Ash (Native) 75Lt Mature H x S: 8-10m x 6-7m


Botanical Name: Banksia integrifolia **Common Name:** Coastal Banksia (Native) Pot size: 75Lt

Mature H x S: 6-8m x 4-5m Qty Required:

Botanical Name: Melaleuca linarifolia Common Name: Snow in Summer (Native) 75Lt Pot size: Mature H x S: 8m x 4-6m

Qty Required: 1 Botanical Name: Backhousia citriodora

Common Name: Lemon Scented Myrtle (Native) 75Lt Pot size: Mature H x S: 6-10m x 4-5m Qty Required: 1

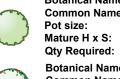

Pot size: Mature H x S: Qty Required:

Pot size: Mature H x S: Qty Required:

S Pot size: Mature H x S: Qty Required:



SHRUBS AND HEDGES

Botanical Name: Westringia 'Aussie Box' Common Name: Westringia Aussie Box (Native) 200mm 0.9m x 0.9m

8


Botanical Name: Callistemon citrinus 'White Anzac' Common Name: Callistemon White Anzac (Native) 300mm 1.4m x 2m 4

FEATURE PLANTS Pot size:

Botanical Name: Phormium tenax 'Purpureum' **Common Name:** New Zealand Flax (Exotic) 300mm Mature H x S: 0.9m x 0.9m Qty Required: 4

GROUNDCOVERS & GRASSES

Botanical Name:	Lomandra longifollia 'Ta
Common Name:	Dwarf Mat Rush (Native
Pot size:	150mm
Mature H x S:	0.8m x 0.8m
Qty Required:	19
Botanical Name:	Dianella Tasred
Common Name:	Native Flax (Native)
Pot size:	140mm
Mature H x S:	0.3m x 0.4m
Qty Required:	11

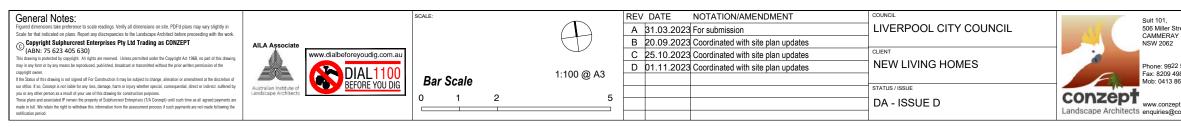

5 Botanical Name: Callistemon 'Better John' Common Name: Better John Bottlebrush (Native) 200mm 1m x 0.9m 6






anika

Pot size: Mature H x S: Qty Required: Pot size: Mature H x S: Qty Required:

Botanical Name: Myoporum parvifolium 'Yareena' Common Name: Creeping Boobialla (Native) 140mm 0.15m x spreading 7/m2 (5.6m2 total) Botanical Name: Casuarina glauca 'Cousin It' Common Name: Cousin It Casuarina (Native) 140mm 0.1m x 1.5m 5/m2 (6.1 m2 total)

	TITLE:	DWG.No:	
eet,	LANDSCAPE PLAN	LPDA 23	-235 / 26
	(LOT 16&17)	DATE:	
5312 32 1 351	PROPOSED RESIDENTIAL SUBDIVISION	NOV	2023
	280 FIFTH AVE	DRAWN:	CHECKED:
.net.au nzept.net.au	AUSTRAL	C.D/L.Z	R.F

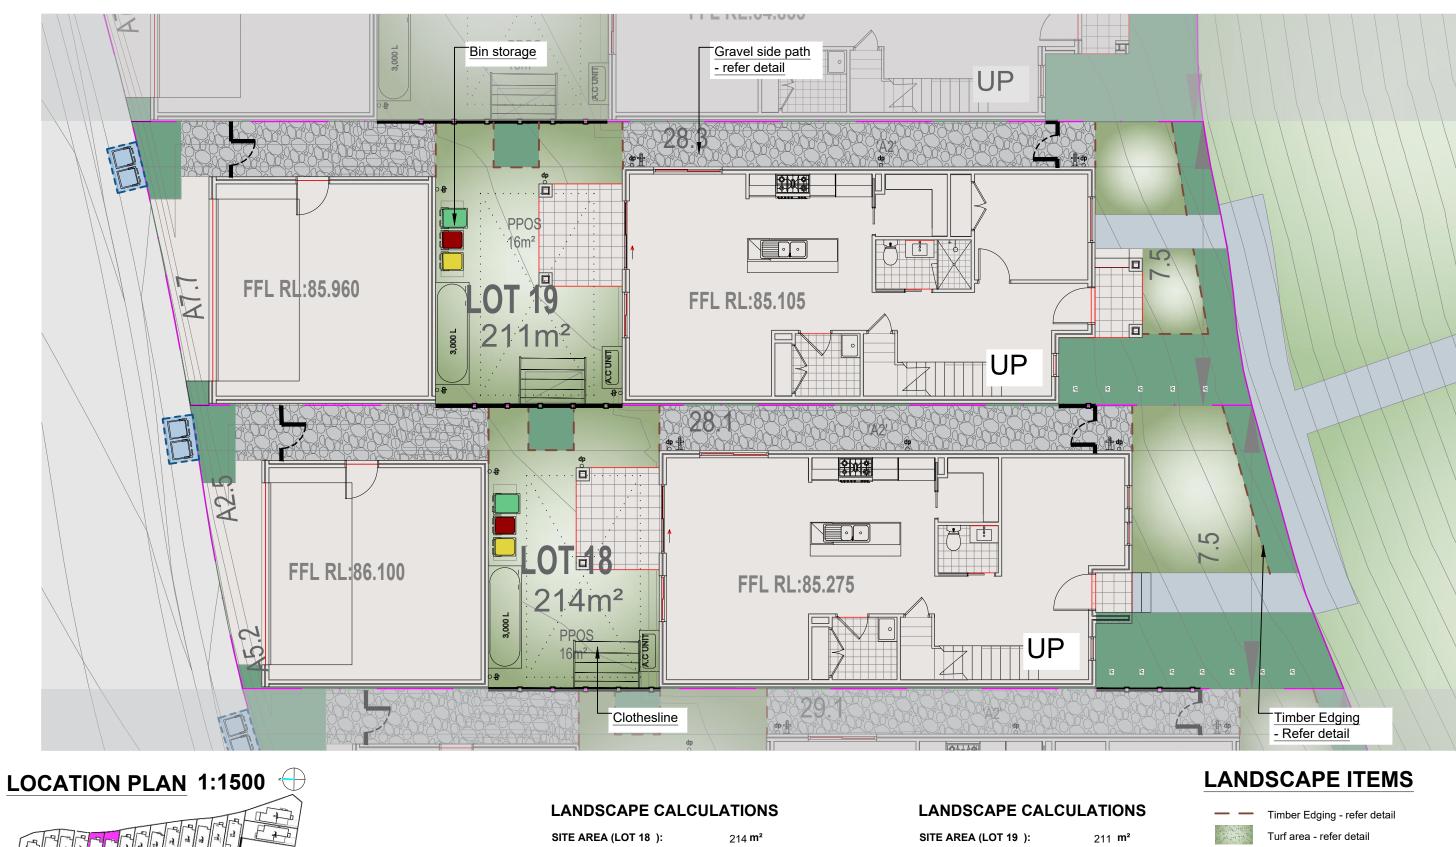

REQUIRED LANDSCAPE AREA: 52.12 m² (25%) PROPOSED LANDSCAPE AREA: 55.7 m²

(COMPLIANT)

LANDSCAPE AREA INCLUDE IN CALCULATION:

REV DATE NOTATION/AMENDMENT General Notes: Suit 101, 506 Miller Stree CAMMERAY LIVERPOOL CITY COUNCIL Ŧ A 31.03.2023 For submission ale for that indicated on plans. Report any (na with the wor Copyright Subpurcest Enterprises Pty Ltd Trading as CONZEPT (ABN: 75 623 405 630) B 20.09.2023 Coordinated with site plan updates NSW 2062 AILA A ww.dialbeforeyoudig.com.au C 25.10.2023 Coordinated with site plan updates NEW LIVING HOMES DIAL1100 BEFORE YOU DIG D 01.11.2023 Coordinated with site plan updates none: 9922 5 1:100 @ A3 Fax: 8209 4982 Mob: 0413 861 Bar Scale Australian Institut STATUS / ISSU 1 Conzept Landscape Architects enquiries@cc 2 5 0 DA - ISSUE D ade in full. We retain the riv tion from the assessment process if such navments are not made following th

(COMPLIANT) LANDSCAPE AREA INCLUDE IN CALCULATION:

PROPOSED LANDSCAPE AREA: 59.5 m²

REQUIRED LANDSCAPE AREA: 53.5 m² (25%)

	10.2				
200		20	1.7	15	. 1





1.8m Gate and fence - colour and style to be nom. by client




Clothesline



Decorative gravel mulch

TITLE:	DWG.No:		
HARDSCAPE PLAN	LPDA 23-235 / 27		
(LOT 18&19)	DATE:		
PROPOSED RESIDENTIAL SUBDIVISION	NOV	2023	
280 FIFTH AVE	DRAWN:	CHECKED:	
AUSTRAL	C.D/L.Z	R.F	
	(LOT 18&19) PROPOSED RESIDENTIAL SUBDIVISION 280 FIFTH AVE	HARDSCAPE PLAN LPDA 23- (LOT 18&19) DATE: PROPOSED RESIDENTIAL NOV SUBDIVISION 280 FIFTH AVE DRAWN:	HARDSCAPE PLAN LPDA 23-235 / 27 (LOT 18&19) DATE: PROPOSED RESIDENTIAL NOV 2023 SUBDIVISION DRAWN: 280 FIFTH AVE DRAWN:

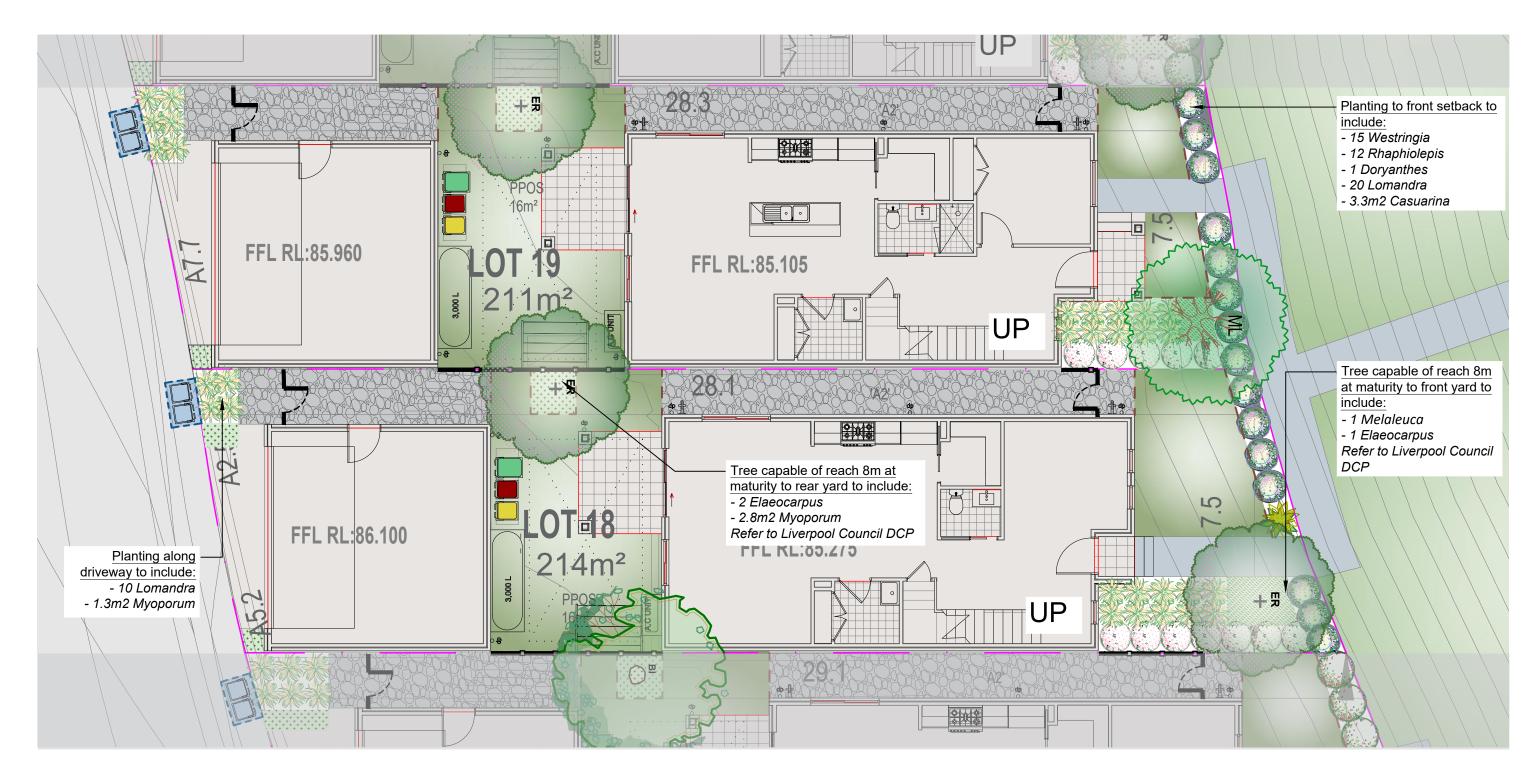

1. ALL FINAL PLANT QUANTITIES INDICATED ON PLANS SHALL BE CHECKED AND VERIFIED BY SUCCESSFUL LANDSCAPE CONTRACTOR. 2. ANY PLANT SUBSTITUTES REQUIRED DUE TO UNAVAILABILITY SHALL BE

RECOMMENDED BY THE LANDSCAPE CONTRACTOR TO BEST MATCH SUBSTITUTED PLANTS AND APPROVED PRIOR TO PURCHASING BY THE LANDSCAPE ARCHITECT. 3. WORKS CERTIFIED FOR FINAL OCCUPANCY CERTIFICATE ARE TO MATCH

APROVED LANDSCAPE PLANS. 4. LANDSCAPE CONTRACTOR SHALL LOCATE AND AVOID SITE STORM WATER & DRAINAGE SERVICES. LOCATE TREES A MINIMUM 1.25M FROM PITS 5. ALL PLANTING AROUND EXISTING TREES SHALL BE ADJUSTED TO AVOID DAMAGE AND CLASHING WITH SURFACE ROOTS.

AND CLASHING WITH SURFACE NOTIS. 6. THE NATURE STRIP (STREET FRONTAGE) FOR THE SITE IS PUBLIC LAND, AND ONLY AUTHORIZED WORKS MAY OCCUR HERE. EXISTING CONDITIONS SUCH AS STREET TREES, COUNCIL PLANTING ETC SHALL BE RETAINED AND PROTECTED DURING CONSTRUCTION, UNLESS SPECIFIC APPROVAL HAS BEEN GRANTED FOR NEW WORK IN THIS AREA. 7. ALL TREES TO BE SOURCED IN ACCORDANCE WITH TESTS AND MEASUREMENTS

CONTAINED WITHIN AS 2303-2015 - TREE STOCK FOR LANDSCAPE USE

TREES

Mature H x S:


Qty Required:

St

Botanical Name: Elaeocarpus reticulatus Common Name: Blueberry Ash (Native) Pot size: 75Lt 8-10m x 6-7m Mature H x S:

Qty Required: 3 Botanical Name: Melaleuca linarifolia Common Name: Snow in Summer (Native) Pot size: 75Lt

8m x 4-6m

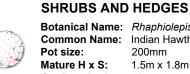

Pot size:

Botanical Name: Rhaphiolepis indica Common Name: Indian Hawthorn (Exotic) 200mm 1.5m x 1.8m 12 Qty Required:

Botanical Name: Westringia 'Aussie Box' Common Name: Westringia Aussie Box (Native) 200mm Mature H x S: 0.9m x 0.9m

Qty Required: 15

FEATURE PLANTS

Botanical Name: Doryanthes excelsa Common Name: Gymea Lily (Native) Pot size: 300mm Mature H x S: 1.1m x 1m Qty Required: 1

GROUNDCOVERS & GRASSES Botanical Name: Lomandra longifollia 'Tanika' **Common Name:** Dwarf Mat Rush (Native) 150mm Pot size: Mature H x S: 0.8m x 0.8m Qty Required: 30

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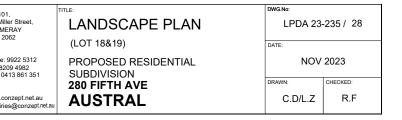





Pot size: Mature H x S: Qty Required: Common Name: Pot size: Mature H x S: Qty Required:

Botanical Name: Myoporum parvifolium 'Yareena' Common Name: Creeping Boobialla (Native) 140mm 0.15m x spreading 7/m2 (4.1m2 total) Botanical Name: Casuarina glauca 'Cousin It' Cousin It Casuarina (Native) 140mm 0.1m x 1.5m


5/m2 (3.3m2 total)



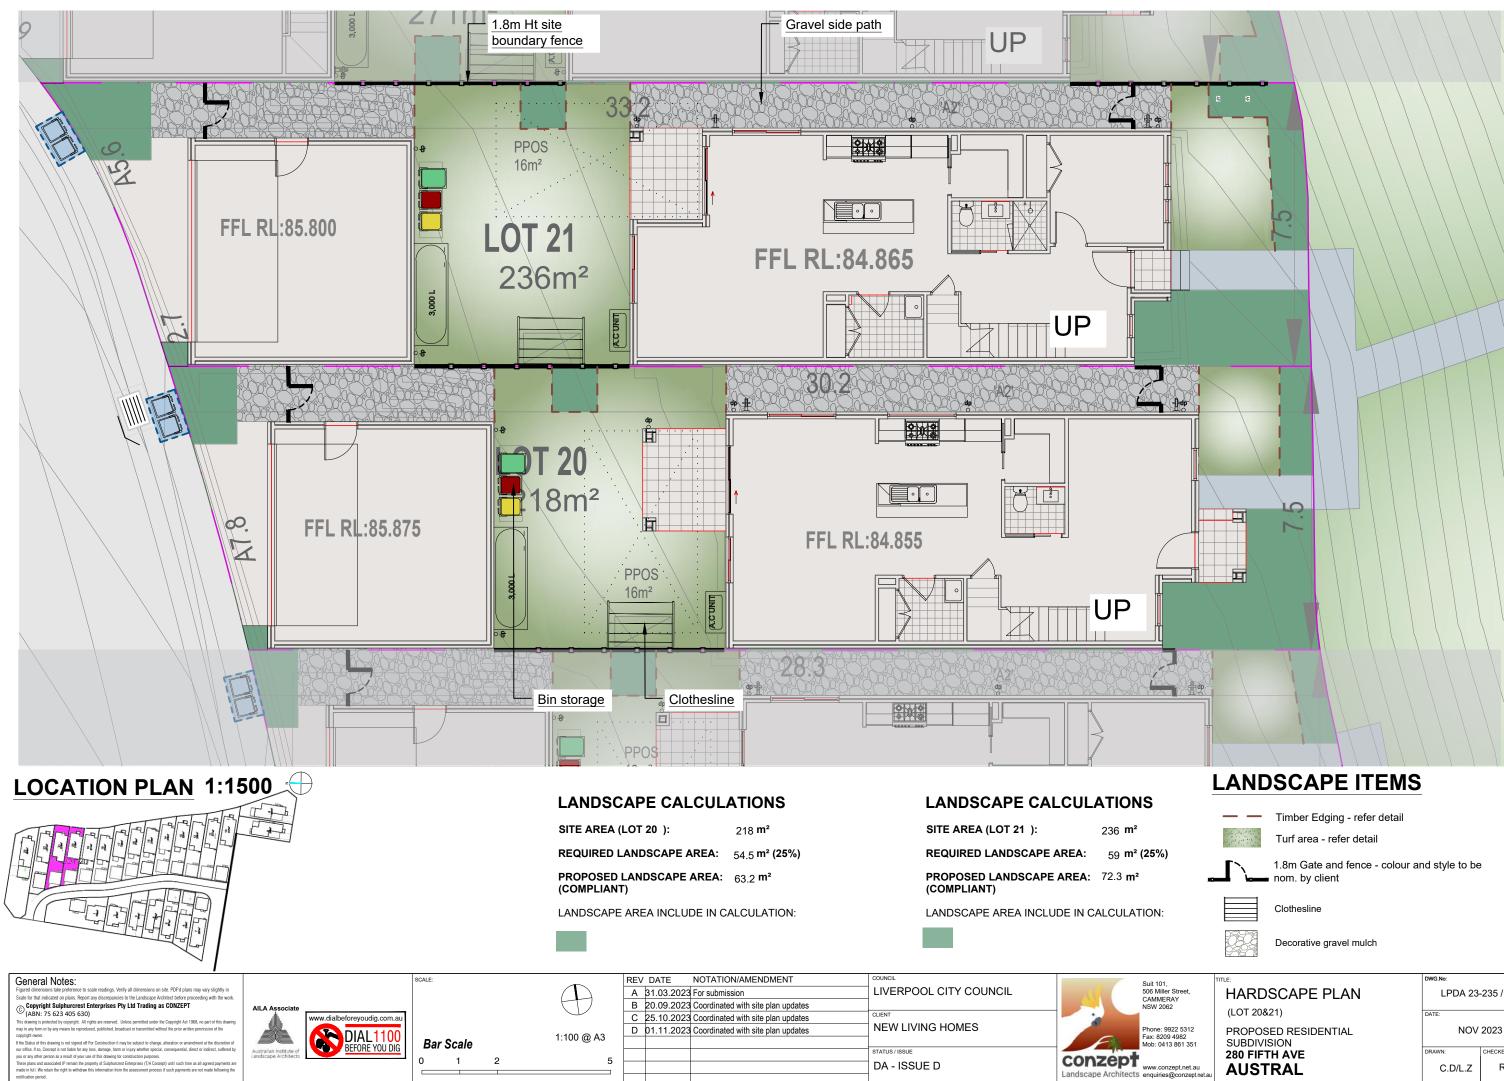

	Sec. 2	10.1	
1. 1. 1		÷	25.

	TITLE:	DWG.No:		
eet,	HARDSCAPE PLAN	LPDA 23	-235/29	
	(LOT 20&21)	DATE:		
5312 32 1 351	PROPOSED RESIDENTIAL SUBDIVISION	NOV	2023	
	280 FIFTH AVE	DRAWN:	CHECKED:	
.net.au nzept.net.au	AUSTRAL	C.D/L.Z	R.F	

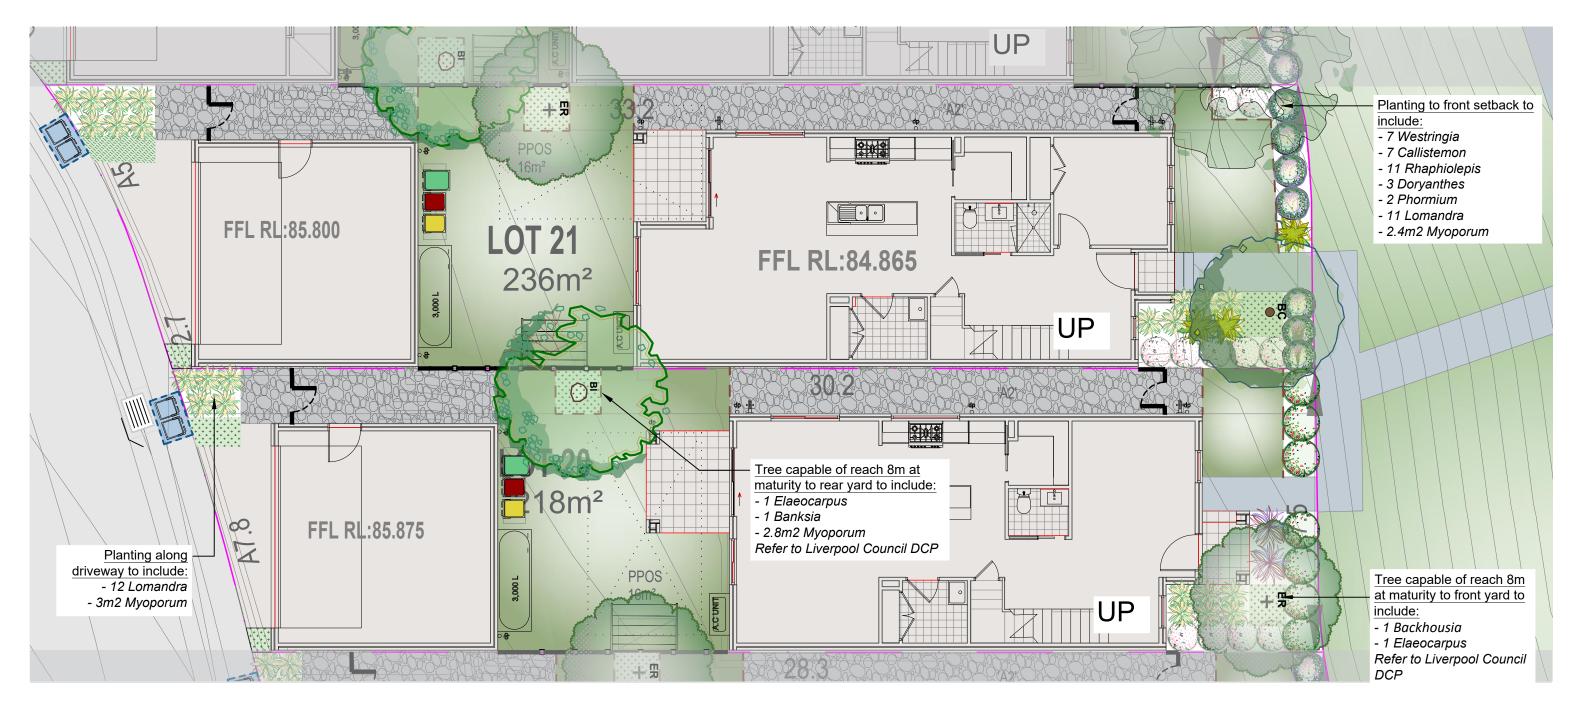

NOTES:

1. ALL FINAL PLANT QUANTITIES INDICATED ON PLANS SHALL BE CHECKED AND VERIFIED BY SUCCESSFUL LANDSCAPE CONTRACTOR. 2. ANY PLANT SUBSTITUTES REQUIRED DUE TO UNAVAILABILITY SHALL BE

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DRAINAGE SERVICES. LOCATE TREES A MINIMUM 1.25M FROM PITS 5. ALL PLANTING AROUND EXISTING TREES SHALL BE ADJUSTED TO AVOID DAMAGE AND CLASHING WITH SURFACE ROOTS.

6. THE NATURE STRIP (STREET FRONTAGE) FOR THE SITE IS PUBLIC LAND, AND ONLY AUTHORIZED WORKS MAY OCCUR HERE. EXISTING CONDITIONS SUCH AS STREET TREES, COUNCIL PLANTING ETC SHALL BE RETAINED AND PROTECTED DURING CONSTRUCTION, UNLESS SPECIFIC APPROVAL HAS BEEN GRANTED FOR NEW WORK IN THIS AREA.

7. ALL TREES TO BE SOURCED IN ACCORDANCE WITH TESTS AND MEASUREMENTS CONTAINED WITHIN AS 2303-2015 - TREE STOCK FOR LANDSCAPE USE

	TREES	
2		Elaeocarpus reticulatus Blueberry Ash (Native)
	Pot size:	75Lt
>		Blueberry Ash (Native) 75Lt

8-10m x 6-7m Mature H x S: Qty Required: 2

Pot size: 75Lt Mature H x S: 6-8m x 4-5m Qty Required:

Pot size: Mature H x S:

Ö



Botanical Name: Banksia integrifolia **Common Name:** Coastal Banksia (Native)

Botanical Name: Backhousia citriodora

Common Name: Lemon Scented Myrtle (Native) 75Lt 6-10m x 4-5m 1



Pot size: Mature H x S: Qty Required: 7

SHRUBS AND HEDGES

Pot size: Mature H x S: Qty Required: Pot size: Mature H x S: Qty Required:

Botanical Name: Callistemon 'Better John' Common Name: Better John Bottlebrush (Native) 200mm 1m x 0.9m

Botanical Name: Westringia 'Aussie Box' **Common Name:** Westringia Aussie Box (Native) 200mm 0.9m x 0.9m

Botanical Name: Rhaphiolepis indica Common Name: Indian Hawthorn (Exotic) 200mm 1.5m x 1.8m 11

Common Name: New Zealand Flax (Exotic) Pot size: Mature H x S:

Qty Required: 2 Pot size: Mature H x S: Qty Required:

FEATURE PLANTS

Botanical Name: Dorvanthes excelsa Common Name: Gymea Lily (Native) 300mm 1.1m x 1m 3

300mm

0.9m x 0.9m

Cenceral Notes: Figure d dimensions take preference to scale readings. Verify all dimensions on site. PDFd plans may vary slightly in Scale for that indicated on plans. Report any discregancies to the Landscape Architect before proceeding with the work. © Copyright Supportcress: Enterprises PDL Ld Trading as CONZEPT (Markow 1997) (Markow 1997) (Markow 1997) (Markow 1997) (Markow 1997) (Markow 1997) (Markow 1997) may in any form of your points. All rights are neared. Unless permitted without the piror writins permission of the copyright assum. It is channed in the drawing its ray loss of the To Construction in my be subject to change, ultration or amediment at the discretion of our any discretion associated in any form, dimang, have are in right permitting permission of the discretion of our any other persons an actual of para one of this daning for construction proposes. There plane as accouncil and associated in any loss, discretion Engense (17, Accouncil) until such line as all agreed payments are	ALLA Associate www.dialbeforeyoudig.com.au www.dialbeforeyoudig.com.au DIAL1100 BEFORE YOU DIG	SCALE: Bar Scale 0 1 2	1:100 @ A3	B 20.09.202 C 25.10.202	NOTATION/AMENDMENT 3 For submission 3 Coordinated with site plan updates 3 Coordinated with site plan updates 3 Coordinated with site plan updates	COUNCIL LIVERPOOL CITY COUNCIL CLIENT NEW LIVING HOMES STATUS / ISSUE DA - ISSUE D	conzept	Suit 101, 506 Miller Street, CAMMERAY NSW 2062 Phone: 9922 5312 Fax: 8209 4982 Mob: 0413 861 35 www.conzept.net.
These plans and associated P remain the property of Sulphurcrest Enterprises (T/A Concept) until such time as all agreed payments are made in full. We retain the right to withdraw this information from the assessment process if such payments are not made following the notification period.			5			DA - ISSUE D	Landscape Architects	www.conzept.net.

GROUNDCOVERS & GRASSES

Botanical Name: Phormium tenax 'Purpureum'

Pot size: Mature H x S: Qty Required: 23


Pot size: Mature H x S:


Qty Required:

Botanical Name: Lomandra longifollia 'Tanika' Common Name: Dwarf Mat Rush (Native) 150mm 0.8m x 0.8m

Botanical Name: Myoporum parvifolium 'Yareena' **Common Name:** Creeping Boobialla (Native) 140mm 0.15m x spreading 7/m2 (8.2m2 total)


1.	TITLE:	DWG.No:	
ller Street, ERAY 062	LANDSCAPE PLAN	LPDA 23-	-235 / 30
	(LOT 20&21)	DATE:	
9922 5312 209 4982 413 861 351	PROPOSED RESIDENTIAL SUBDIVISION	NOV	2023
	280 FIFTH AVE	DRAWN:	CHECKED:
onzept.net.au es@conzept.net.au	AUSTRAL	C.D/L.Z	R.F

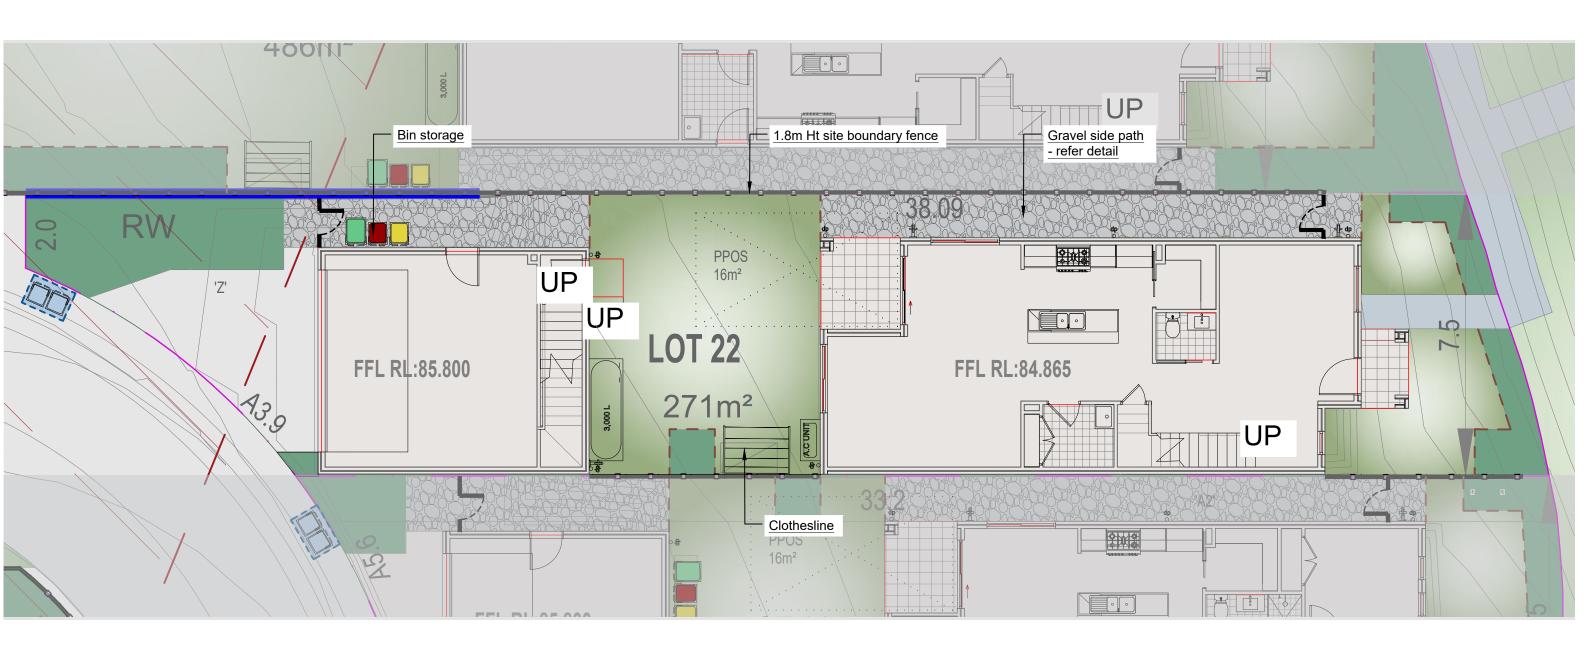

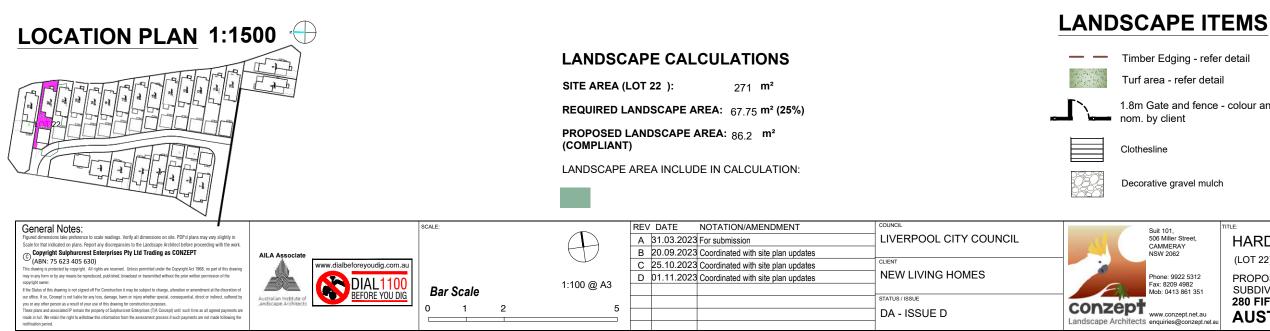

1.8m Gate and fence - colour and style to be

	TITLE:	DWG.No:	
reet,	HARDSCAPE PLAN	LPDA 23	-235 / 31
	(LOT 22)	DATE:	
5312 182 51 351	PROPOSED RESIDENTIAL SUBDIVISION	NOV	2023
	280 FIFTH AVE	DRAWN:	CHECKED:
t.net.au onzept.net.au	AUSTRAL	C.D/L.Z	R.F

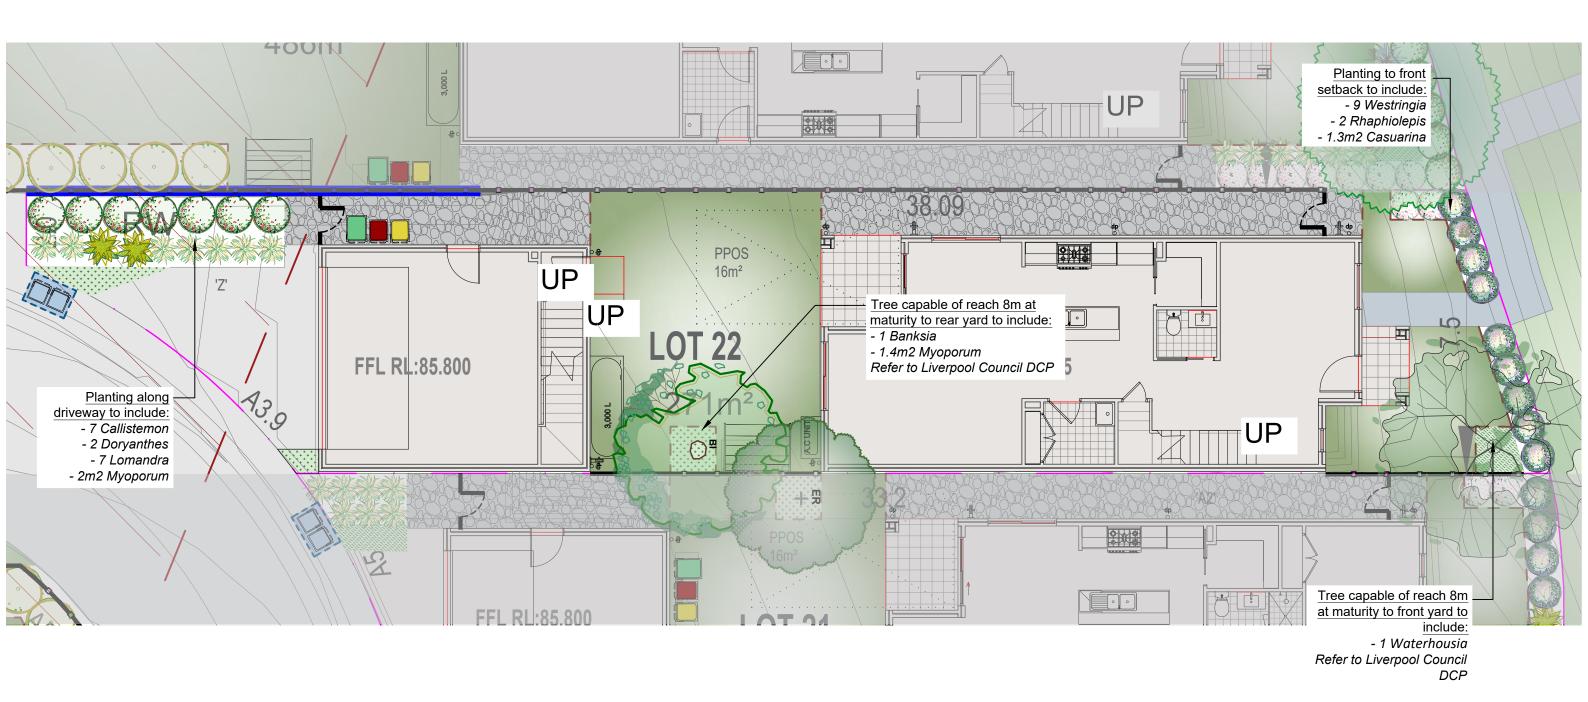

NOTES

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DRAINAGE SERVICES. LOCATE TREES A MINIMUM 1.25M FROM PITS 5. ALL PLANTING AROUND EXISTING TREES SHALL BE ADJUSTED TO AVOID DAMAGE AND CLASHING WITH SURFACE ROOTS.

6. THE NATURE STRIP GRADE ROUTS. ONLY AUTHORIZED WORKS MAY OCCUR HERE. EXISTING CONDITIONS SUCH AS STREET TREES, COUNCIL PLANTING ETC SHALL BE RETAINED AND PROTECTED DURING CONSTRUCTION, UNLESS SPECIFIC APPROVAL HAS BEEN GRANTED FOR NEW WORK IN THIS AREA. 7. ALL TREES TO BE SOURCED IN ACCORDANCE WITH TESTS AND MEASUREMENTS

CONTAINED WITHIN AS 2303-2015 - TREE STOCK FOR LANDSCAPE USE

TREES

ö

Botanical Name: Banksia integrifolia **Common Name:** Coastal Banksia (Native) Pot size: 75Lt Mature H x S: 6-8m x 4-5m Qty Required: 1

Botanical Name: Waterhousia floribunda **Common Name:** Weeping Lilly Pilly (Native) Pot size: 75Lt Mature H x S: 10m x 6m Qty Required: 1

SHRUBS AND HEDGES

Pot size: Mature H x S: Qty Required:

Pot size:

Mature H x S: Qty Required:

Botanical Name: Rhaphiolepis indica

Common Name: Indian Hawthorn (Exotic) 200mm 1.5m x 1.8m 2

Botanical Name: Westringia 'Aussie Box' **Common Name:** Westringia Aussie Box (Native) 200mm 0.9m x 0.9m 9

FEATURE PLANTS



Common Name: Gymea Lily (Native) 300mm 1.1m x 1m

2

GROUNDCOVERS & GRASSES Botanical Name: Lomandra longifollia 'Tanika'

Common Name: Dwarf Mat Rush (Native) Pot size: Mature H x S: Qty Required:

150mm 0.8m x 0.8m 7


General Notes: Figured dimensions take preference to scale readings. Verity all dimensions on sale. PDPd plans may vary slightly in Scale for that indicated orperspansies to the Landscape Architect before proceeding with the work. Orgenight Subplacements: Enterprises PUL Ult Trading as ChOZEPT (ABN: 75 623 405 630). This downing practice by rowyrdight. High the reserved. Ultises permitted under the Dowyrdight Act 1989, no part of this dawing rowyrdight. This dawing row of y any mans be reproduced, published, broadcaet or taxonithed without the prior writtes permission of the conception activ. A fastisan of this drawing is not signed for Construction. It may be abgle to brange. Illenation or ammometer at the discription in may. A concept is not like to ray long, dampe, them or higher special, conceptendial, direct or function. Sufficient by any damper as a fauld or your of the special activity of any other praces as a straid or your of the special activity and the special. Conceptendial, direct or function. Sufficient by any main as all concepted poymeths are main to its UNEY of the species of the priority discription. The prior as a straid or your of this order to information or priority. Mark the first to which assumed process if had on the priority discription of the species of the priority discription. The priority of the priority discription of the species of the priority of the priore priority of the priority of the priority o	REV DATE NOTATION/AMENDMENT A 31.03.2023 For submission B 20.09.2023 Coordinated with site plan updates C 25.10.2023 Coordinated with site plan updates D 01.11.2023 Coordinated with site plan updates	COUNCIL LIVERPOOL CITY COUNCIL CLIENT NEW LIVING HOMES STATUS / ISSUE DA - ISSUE D	Suit 101, 506 Miller Street, CAMBERAY NSW 2062 Phone: 9922 531 Fax: 8209 4982 Mob: 0413 861 3 Www.conzept.net
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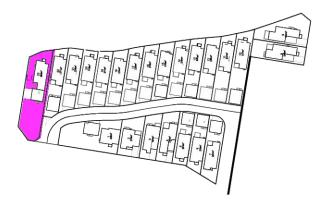
Pot size: Mature H x S: Qty Required: Pot size: Mature H x S: Qty Required:

Botanical Name: Myoporum parvifolium 'Yareena' **Common Name:** Creeping Boobialla (Native) 140mm 0.15m x spreading 7/m2 (3.4m2 total) Botanical Name: Casuarina glauca 'Cousin It' Common Name: Cousin It Casuarina (Native) 140mm 0.1m x 1.5m 5/m2 (1.3m2 total)

	TITLE:	DWG.No:	
street, Y	LANDSCAPE PLAN	LPDA 23-	-235 / 32
	(LOT 22)	DATE:	
2 5312 982 861 351	PROPOSED RESIDENTIAL SUBDIVISION	NOV	2023
	280 FIFTH AVE	DRAWN:	CHECKED:
pt.net.au conzept.net.au	AUSTRAL	C.D/L.Z	R.F



LOCATION PLAN 1:1500 -

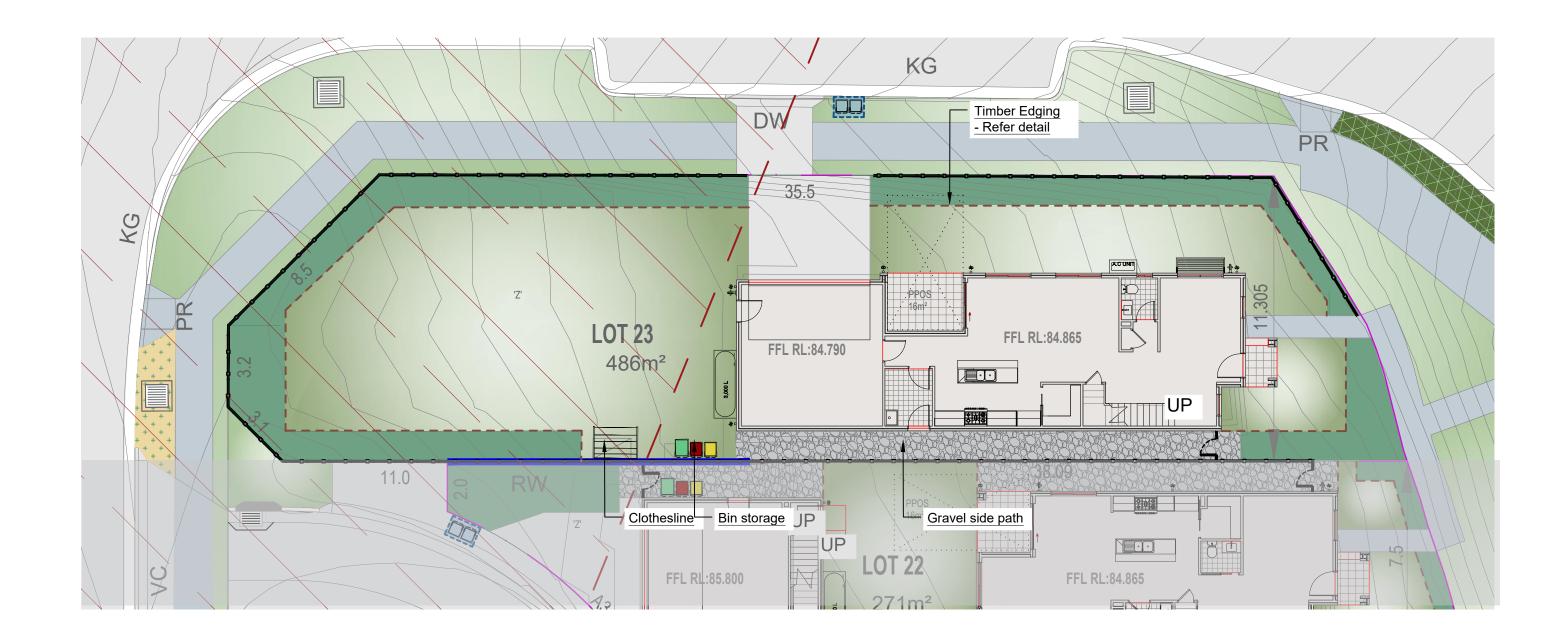

LANDSCAPE CALCULATIONS

SITE AREA (LOT 23):

REQUIRED LANDSCAPE AREA: 121.50 m² (25%)

486 **m²**

PROPOSED LANDSCAPE AREA: 312 m² (COMPLIANT)

LANDSCAPE AREA INCLUDE IN CALCULATION:

LANDSCAPE ITEMS


Timber Edging - refer detail

1.8m Gate and fence - colour and style to be nom. by client





Decorative gravel mulch

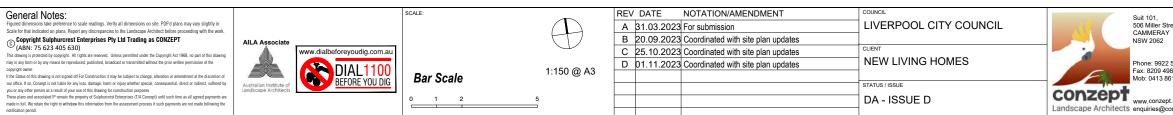




Bin collection area



Bin storage area

Existing Transmission Easement

	TITLE:	DWG.No:	
reet, (HARDSCAPE PLAN	LPDA 23-	-235 / 33
	(LOT 23)	DATE:	
2 5312 982 61 351	PROPOSED RESIDENTIAL SUBDIVISION	NOV	2023
	280 FIFTH AVE	DRAWN:	CHECKED:
ot.net.au onzept.net.au	AUSTRAL	C.D/L.Z	R.F

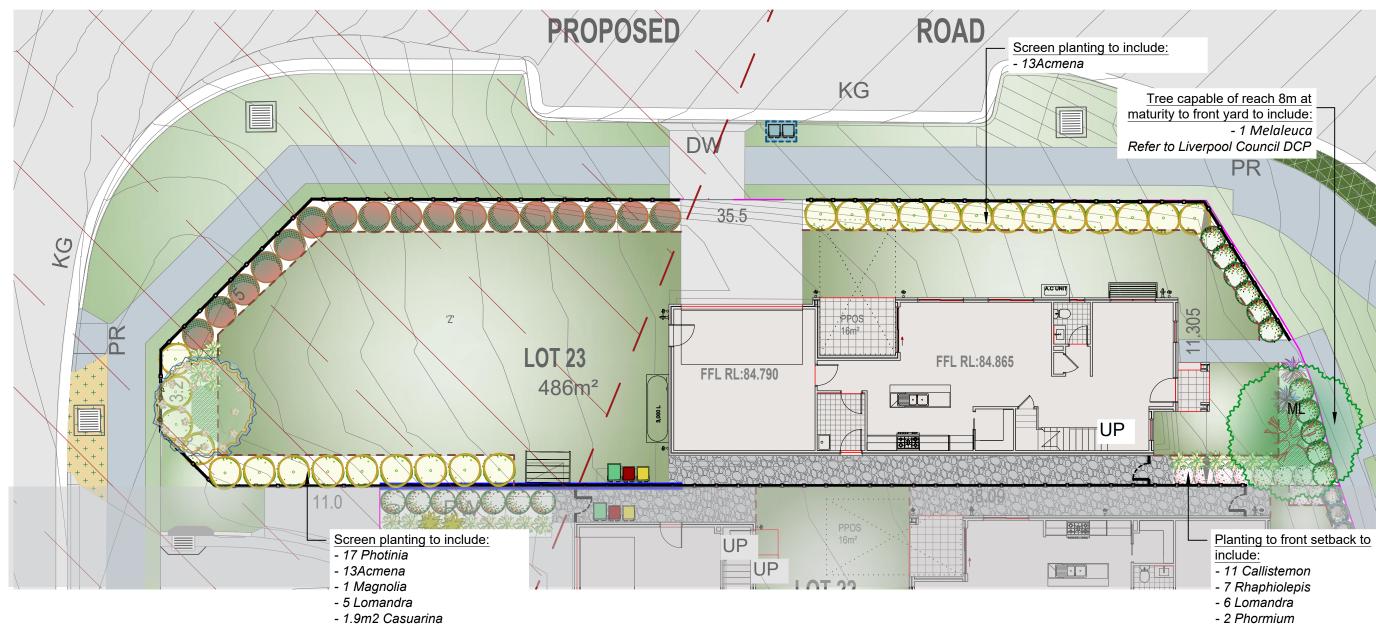

TREES

Botanical Name: Melaleuca linarifolia **Common Name:** Snow in Summer (Native) Pot size: 75Lt Mature H x S: 8m x 4-6m 1

Qty Required: Botanical Name: Magnolia 'Little Gem'

Common Name: Magnolia Little Gem (Exotic) 45Lt Pot size: Mature H x S: 3.0m x 1.5-2m Qty Required: 1

SHRUBS AND HEDGES



Common Name: Better John Bottlebrush (Native) **Common Name:** Red Robin Photinia (Exotic)

Mature H x S:

Qty Required:

FEATURE PLANTS Botanical Name: Phormium tenax 'Purpureum' Common Name: New Zealand Flax (Exotic) 300mm Pot size:

2

0.9m x 0.9m

Pot size:



		Qty Required: 7			
General Notes: Figured dimensions take preference to scale readings. Verify all dimensions on site. PDFd plans may vary slightly in Scale for that indicated on plans. Report any discrepancies to the Landscape Architect before proceeding with the work. Compositive Support Scale Enterprises PDF Life Trading as CONZEPT (ABN: 75.62.3405.630) The State of the staring is protocidely coprigit. All rights are reserved. Unless permitted once the Copyright Act 1968, no part of this drawing may in any ion or by symmetris the models, abulands at the sameline without the protocide protoc	www.dialbeforeyoudig.com.au	Bar Scale 1:150 @ A3	REV DATE NOTATION/AMENDMENT A 31.03.2023 For submission B 20.09.2023 Coordinated with site plan updates C 25.10.2023 Coordinated with site plan updates D 01.11.2023 Coordinated with site plan updates	COUNCIL LIVERPOOL CITY COUNCIL CLIENT NEW LIVING HOMES STATUS / ISSUE DA - ISSUE D	Suit 101, 506 Miller Stree CAMMERAY NSW 2062 Phone: 9922 55 Fax: 8209 4982 Mob: 0413 861 Www.conzepLr Landscape Architects enquiries@con

- 2.1m2 Casuarina

GROUNDCOVERS & GRASSES

Botanical Name: Casuarina glauca 'Cousin It' Common Name: Cousin It Casuarina (Native) 140mm 0.1m x 1.5m Mature H x S: Qty Required: 5/m2 (4m2 total)

Botanical Name: Lomandra longifollia 'Tanika' **Common Name:** Dwarf Mat Rush (Native) 150mm Pot size: Mature H x S: 0.8m x 0.8m Qty Required: 11

Street, Y	LANDSCAPE PLAN	DWG.No: LPDA 23-	-235 / 34		
2 5312 4982 861 351			DATE: NOV 2023		
ept.net.au conzept.net.au	280 FIFTH AVE AUSTRAL	DRAWN: C.D/L.Z	CHECKED: R.F		